07/12/2017 9:25AM 000001 #7150 0001 GLORIA

PERMITS-TYPE 2 \$175.00 NOTICE/TPR \$159.00



Land Use Planning Division 1600 SE 190th Ave, Ste 116 Portland OR 97233 Ph: 503-988-3043

Fax: 503-988-3389 multco.us/landuse

NSA EXPEDITED OR CARD \$334.00 **RESIDENTIAL APPLICATION**

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PROPERTY	
Address 31710 NE WAND RO, TRONTDALE Site Size 2.00 acres	For Staff Use
PROPOSED DEVELOPMENT (check all that apply)	504961
Addition or covered deck: Size 183 (200 sf max) Height 15.5 ft Existing Floor Area 3,024 / (500 sf min) Existing Height 22.5 ft (greater than proposed)	€ASE NUMBER 12.2017.8099
☐ Accessory structure: Size (60 to 200 sf) Height ft (10 ft max)	State ID #
Uncovered, attached deck: Size 42.75 (500 sf max) Height 30" inches (30" max)	1N4E32A - 01800
☐ Demolition: Structure Type Age (less than 50 yrs)	Alt Acct. #
☐ Rail, solid, or semi-solid fence: Height ft (6' max) Length (100' max)	R053503700
☐ Wire strand fence: Height ft (greater than 4') Length (greater than 500')	DATE SUBMITTED
☐ Woven wire fence: Agricultural enclosure only Area fenced (80 ac max)	7.12.17
☐ Pave existing dirt/gravel road: All work to occur within existing road prism	ZONING
☐ Decommission non-paved road: Includes ripping road surface, barriers, revegetation	GGR. ID
☐ Retaining wall: Height ft (2'max exposed surface) Length (100' max)	MCC CITATION (For Qualifying Use)
M Outdoor lights: Onesexterior light at new mandoor (dark sky complime	h
Moutdoor lights: Onesexterior light at new mandoor (hooded of dark sky complimed) Other: Replace windows & add windows to rear of honse.	Related Case No
APPLICANT	Open UR/ZV
Name J.m Greenslade Mailing Address 31710 NE wand rd City Tarattolo State Col. Tipsode 97000 Fax Fax	
City Troutdale State OR Zipcode 97060 E-mail Jin greanslade OWNER	Ву: 72
Name Jim Greenslade Phone 503 849 Street Address 31710 NE Wand vd City Troutdole State OR Zip	9-2127 pecode 97060
I authorize the applicant to make this application.	
Property Owner Signature	
NOTE: By signing this form, the property owner or property owner's agent is granting permission for Planning Staff to conduct site inspections on the property.	
☐ If no owner signature above, a letter of authorization from the owner is required.	

Instructions for applicants:

The checklist below asks you to confirm facts or conditions related to your property and your proposal. The numbered paragraphs in bold represent code requirements or criteria for development in the National Scenic Area (NSA). Those criteria are addressed when you check a box below each numbered paragraph. By checking a box, you are confirming that the corresponding statement applies to your project. Staff concurrence is indicated by initials in the boxes along the right column of this form. Please ensure that you check a box under every numbered paragraph or staff will not be able to process this application under the Expedited Review Process. The NSA Handout #4: Expedited Development Review Process that accompanies this form explains each of the criteria.

Scenic Resources

1. In the General Management Area, the scenic resource protection criteria shall not apply to woven-wire fences for agricultural use that would enclose 80 acres or less.

Staff initial:

This application includes new woven-wire fencing on property that is within the General Management Area (i.e. it is in a zone district that begins with "GG") and the fencing is for agricultural use and encloses an area that is less than 80 acres in size. The scenic resource criteria do not apply to the new woven wire fence.

[Proceed to the Recreational Resource criteria (page 4) if this application is only for fencing. Otherwise, respond to the remaining scenic criteria for other uses or development that are eligible for expedited review.]

This application is not for new woven wire fencing. The scenic resources criteria are applicable.

2. The colors of structures topographically visible from key viewing areas shall be dark earth-tones found at the specific site or the surrounding landscape. The specific colors or list of acceptable colors shall be included as a condition of approval. This guideline shall not apply to additions, which may match the color of existing buildings.

Staff initial:

See NSA
Handout #4:
Expedited
Development
Review
Process, for
list of KVAs

<u>Note to applicant:</u> Show on the site plan the location of the terrain feature or landform that screens the structure with arrows identifying the vantage point from which the site is viewed from the KVA(s).

Attach plan

The application is for an addition. As shown in the attached color chip and site photograph, the addition will match the color of the existing buildings. *This criterion has been met*.

Attach color chip & photo of existing building

Attach color The application is for an addition to or modification of an existing structure, chip(s) & or placement of a new structure that is topographically visible from one or photo(s) of more key viewing areas. As shown in the attached color chip and site structure & photograph, the proposed addition will be dark earth tones that are found at surrounding the site or surrounding landscape. This criterion has been met. landscape 3. Structures topographically visible from key viewing areas shall use low or Staff initial: non-reflective building materials, including roofing, gutters, vents, and chimneys. ne application does not involve a structure that is topographically visible from a key viewing area. This criterion has been met. The application includes structure(s) that are topographically visible from building one or more key viewing areas. As shown in the attached samples, the proposed structure(s) will use low or non-reflective building materials. This samples criterion has been met. 4. Outdoor lights shall be directed downward and sited, hooded, and shielded Staff initial: such that they are not highly visible from key viewing areas. Shielding and hooding materials shall be composed of non-reflective, opaque materials. The application does not include outdoor lights. This criterion is not applicable. The application includes outdoor lights. As shown in the attached Attach spec specification sheet, the proposed lights will be hooded and shielded and are sheet here composed of non-reflective, opaque materials. A site plan and/or elevation drawings shows the location of the lighting. Based on these drawings the lighting will not be highly visible from key viewing areas. This criterion has been met. 5. Structures within ½-mile of a key viewing area and topographically visible Staff initial: from the key viewing area shall be sited, screened and/or designed to achieve ΧE the applicable scenic standard (e.g., visual subordinance, not visually evident). The application does not involve a structure that is within ½-mile of and topographically visible from a key viewing area. This criterion is not applicable. ☐ The application includes structure(s) that are within ½-mile of and Attach topographically visible from (a) key viewing area(s). As shown on the elevations or attached site plan, and exterior architectural elevations or rendered photo, photo of the proposed structure(s) will be sited, screened, and/or designed so that it structure achieves the standard of: \square visual subordinance, or \square not visually evident Explain how standard is achieved. See NSA Handout #5: Designing for Approval This criterion has been met.

Recreation Resources	£ .
The development shall not detract from the use and enjoyment of established recreation sites on adjacent parcels.	Staff initial
The attached site plan labels the uses on adjacent parcels. There is no established recreation site on an adjacent parcel. <i>This criterion is not applicable</i> .	Label adjacent
☐ The attached site plan labels show that the property is adjacent to at least one established recreation site, but does not detract from the use and enjoyment of the site. The proposed development will not generate noise, dust, or ●dors at levels significant enough to impact the use. Also, the site plan shows that the proposed development would not interfere with access to the adjacent recreation site(s). <i>This criterion has been met</i> .	uses on attached site plan
Cultural Resources	
7. The expedited development review process shall only be used to review proposed development that does not require a reconnaissance survey or historic survey.	Staff initial:
Note to applicant: If an Indian tribe sends a letter in response to the application indicating that the proposal affects a treaty right or cultural resource, then the application can not be reviewed using the expedited development review process.	
Reconnaissance Survey	
Proposed development does not require a reconnaissance survey if it meets <u>any</u> of the following (check at least one that applies):	
Is limited to the modification, expansion, replacement, or reconstruction of existing buildings and structures.	
☐ Will not disturb the ground (e.g. storage shed without a foundation)	
☐ Occurs on a site that was previously disturbed by human activities where the depth and extent of the grading does not exceed prior ground disturbance.	Show area and type of disturbance on plan
Involves minor ground disturbance, as defined by depth and extent (e.g. fence construction, footings for a deck, etc.)	
Width 10 x Length 20 x Depth 18"	
Note to applicant: The project will not qualify for expedited review if the Gorge Commission disagrees that the activity results in minor disturbance.	
☐ Occurs on a site that has been adequately surveyed in the past, or has been identified by the Gorge Commission, USFS Archaeologist, or private	Attach survey

archaeologist as having a low probability of containing cultural resources.

This criterion has been met.

Historic Survey

A historic survey is not required for the following activities (check at least one):

There are no structures 50 years old or older on the property.


There is/are structures 50 years old or older; however, the application does not alter the structure(s), nor does it compromise features of the surrounding area that help define the historic character of the structure(s).

This criterion has been met.

Natural Resources

- 8. The development is outside buffer zones for wetlands, streams, rivers, ponds, and lakes. This guideline shall not apply to development located inside road, utility or railroad rights-of-way or easements that have been previously disturbed and regularly maintained.
- ☐ The proposal is for development located inside road, utility or railroad rights-of-way or easements that have been previously disturbed and regularly maintained. *This criterion is not applicable.*
- As shown on the attached site plan, proposed development is outside buffer zones for wetlands, streams, rivers, ponds, and lakes. *The criterion has been met*.
- 9. The development will not adversely impact sensitive wildlife or plant species or is at least 1,000 feet from known sensitive wildlife areas or sites (excluding sensitive aquatic species, deer winter range, and turkey habitat) and known sensitive plants. This guideline shall not apply to development that does not disturb the ground or is located inside road, utility or railroad rights-of-way or easements that have been previously disturbed and regularly maintained.
- As shown on the attached site plan and confirmed by planning staff, the proposed development is over 1,000 feet from known sensitive wildlife areas or sites (excluding sensitive aquatic species, deer winter range, and turkey habitat) and known sensitive plants. This criterion has been met.
- ☐ The proposed development does not disturb the ground or is inside road, utility or railroad rights-of-way or easements or other areas that have been previously disturbed and regularly maintained. *This criterion is not applicable*.
- Although proposed development is within 1,000 feet of a known sensitive wildlife area or site, the Oregon Department of Fish and Wildlife (for GMA lands) or U.S. Forest Service (SMA lands) has determined that the area or site is not active, that development will not compromise the integrity of the wildlife area or site, or that development will not occur during a time of year that the wildlife species are sensitive to disturbance.
- ☐ Although proposed development is within 1,000 feet of known sensitive plants, a representative of the Oregon Natural Heritage Program or an expert in botany or plant ecology has determined that development will not occur within 200 feet of a sensitive plant species.



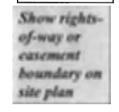

Staff initial:

See land use staff for agency contacts

Attach agency confirmation

NOTICE OF PRELIMINARY DECISION

In accepting this application for expedited review, the Planning Director is granting preliminary approval of the development. The Gorge Commission, U.S. Forest Service, Indian tribal governments, and property owners within 750 feet of the subject tract will be given 14 days to provide comments. If no comments are received, the decision shall become final at the close of business on the 14th day. If substantive written comments are submitted, the Planning Director will either modify the decision to address the comments and re-issue it for a 14-day appeal period or re-direct the application to full review if comments establish that the proposed development is not eligible for expedited review.

Comments must be directed to the applicable approval criteria. Those in **bold** above are listed in MCC 38.7100 of the County code. Failure to provide comments during the comment period will preclude a right to appeal.

Conditions/Limitations of Approval

- 1. If, during construction, cultural or historic resources are discovered, the applicant/owner shall immediately cease development activities and inform the Multnomah County Land Use Planning Division, Columbia River Gorge Commission, and the U.S. Forest Service of any discovery pursuant to MCC 38.7045(L) & (M), or MCC 38.7050(H) as applicable. Once halted, construction activities shall not resume until these standards have been satisfied.
- 2. Approval of this land use permit is based upon the statements made in this application and attached materials. No work shall occur under this permit other than that which is specified in these documents.
- 3. Development of structures must be commenced within 2 years of the date of this decision, and completed within 2 years of the date of commencement. The property owner may request an extension of either of these timeframes, as provided in MCC 38.0700. Such a request must be made prior to expiration of the permit.

This decision is final at the close of the comment period unless comments are received. If no comments are received, the effective date of the decision is $4 \mu M$

comments are received, the effective date of the decision is Avgust 7, 26 1) 4 pm
FOR STAFF USE	
At close of the comment period (check one that applies):	Staff initial:
☐ No substantive written comments were received. The decision is final.	
Substantive written comments were received. The Planning Director will issue a letter addressing the comments and may modify this preliminary decision.	Date:
☐ Written comments were submitted showing that the proposed development is not elifor expedited review. The project will be reviewed using the full development review process.	0
Any comments received are included in the County records for this application.	

Fill out NSA DR Database Form for Gorge Commission and include copy with file.

Camille

S:00 am http://catbird/property.asp?PropertyID=R111649



Property Information

Property Information

Tax Summary Assessment History

Improvement Information

New Search

Search Results

Printable Summary

Logoff.

Search Results for R111649

Pay Now

Owner Name

GREENSLADE, JAMES M & GREENSLADE, CAMILLE R **Property ID Number**

R111649

Situs Address

Neighborhood

Owner Address

31710 NE WAND RD TROUTDALE, OR 97060-9343 31710 NE WAND RD TROUTDALE, OR 97060

Alternate Account Number

R053503700

R020

Map Tax Lot

Levy Code Area - Taxing Districts

1N4E32A -01800

358

Portland Maps

Information on Ordering Copies

Click to Open Map

Click to Open Order Form

Property Description

Exemption

Expiration Date

Tax Roll Description

321N4E

Map Number

1N4E32A -01800

Parcel

Account Status

A - Active

Property Use

Year Built Acreage

B - RESIDENTIAL IMPROVED

BANNER AC, S 145' OF LOT 36 EXC PT IN ST

1968

Related Accounts

Linked Accounts

Split/Merge Account

Split/Merge Account Message

Special Account Information

NSA 6-94

GGRIO

Sales Information

Consideration Grantor Grantee Deed Instrument Date **Amount** (Seller) (Buyer) DENT GREENSLADE, JAMES GREENSLADE, JAMES 2016135883 10/28/16 M & GREENSLADE, JAMES BP19182228 07/08/86 WD TOWSLEY, MARY \$68,000

Μ

2017 Land Information (Unedited and Uncertified)

ID	Туре	Acres	Sq Ft
L1	RES - RESIDENTIAL LAND	2.00	87120

INFORMATION SUBJECT TO DISCLAIMER - SEE HOME PAGE

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Land Use Planning Division 1600 SE 190th Ave, Ste 116 Portland OR 97233 Ph: 503-988-3043 Fax: 503-988-3389

multco.us/landuse


FIRE SERVICE AGENCY **REVIEW**

TO THE APPLICANT: Take this form to the Structural Fire Service Provider* that serves your property along with the following:
☐ A site plan drawn to scale showing the subject property, its improvements, location of fire hydrants and driveway information;
☐ A floor plan of the proposed development; and
☐ A fire flow report from your water purveyor (if applicable) [Not applicable for Properties served by MCRFD#14 customers]
After the fire official signs this form, include it with your application material. See Fire Code Application Guide for fire-related access standards and fire flow information. *If your property is not served by a structural fire service provider, your project is to be reviewed by the appropriate building official serving your property.
Address of Site 31710 NE Wand rd Trout Sale OR 97060
Map & Tax Lot: Banner Acres 'R' number Lot 36
Description of Proposed Use:
Total Square Footage of Building (including roof projections, eaves & attached structures): 1,600 square
Applicant Name: Jun Greenslade Phone: 503 849-2127
City Transtable State: PR 7in Code: A 74/Email: 1 2 20 20 Clade
Mailing Address: 31710 NE Wand rd City: Troutdale State: OR Zip Code: 97060 Email: j.m.greenslade @ceg.us.com
STRUCTURAL FIRE SERVICE AGENCY REVIEW Fire Agency completing this form: Fire Double of Review 7-9-17
The subject property is located within our service boundaries or is under contract.
The subject property is located <u>within</u> our service boundaries and <u>will not</u> be providing fire protection services via contract. (Additional review is not needed.)
** Access Review by Structural Fire Service Agency Providing Service **
The proposed development is in compliance with the fire apparatus access standards of the Oregon Fire Code standards as implemented by our agency.
☐ The following access improvements must be completed <u>prior to issuance of the building permit</u> and be re-inspected by our agency before flammable materials are placed on the property.
☐ The proposed development is not in compliance with the adopted Fire Service Agency's access standards. The proposed building/structure is required to have a fire sprinkler system installed in compliance with Section 903.1.3 (NFPA 13D) of the Oregon Fire Code.

Fire Official: Please sign or stamp the presented site plan & floor plan and attach it to this form.

Signature & Title of Fire Official

STRUCTURAL FIRE SERVICE AGENCY REVIEW, CONTINUED.
** Fire Flow by Structural Fire Service Agency Providing Service **
☐ The structure, building or addition is exempt from the fire flow standards of the OFC B-105.2.
The proposed non-commercial structure is less than 3,600 sq. ft. (including the horizontal projections of the roof) and there is 1,000 gallons per minute of fire-flow available at 20 psi from public water lines. No mitigation measures are necessary.
☐ The proposed non-commercial structure is more than 3,600 sq. ft. (including the horizontal projections of the roof) and the fire-flow & flow duration at 20 psi is available from public water lines or private well and is in compliance with minimums specified in Appendix B, Table B105.1 of the Oregon Fire Code. No mitigation measures are necessary.
☐ The existing fire-flow & flow duration available from public water lines or private well is not adequate to serve the proposed non-commercial structure in compliance with Appendix B of the Oregon Fire Code. The following mitigation measures are necessary* and must be installed prior to occupancy or use of the structure.
O A monitored fire alarm must be installed
O A Class A or non-combustible roof materials must be installed.
O Defensible space of 30 feet around the structure/building/addition.
O A defensible space of 100 feet around the structure/building/addition due to slopes greater than 20 %.
 A fire sprinkler system meeting Section 903.1.3 (NFPA13D) of the Oregon Fire Code shall be installed. Other
O Journel
*The above required structural features are required by the Oregon Fire Code and shall be shown clearly on all building plans.
Commercial/Industrial Buildings & Uses.
The minimum fire flow and flow duration is available from public water lines or private well as specified in Appendix B, Table B105.1. No mitigation measures are required.
The minimum fire flow & flow duration is not available from public water lines or private well as specified in Appendix B, Table B105.1. The following mitigation measures are required:
De Frachet
Signature & Title of Fire Official
To the Fire Official:
O Land Use Planning has determined that the proposed building will qualify as an Exempt Farm Structure and the property owner has indicated that the building will be used solely for farm purposes and they intend on using the provision under ORS 455.315 and will not be obtaining a building permit for its construction.
Multnomah County Land Use Planning

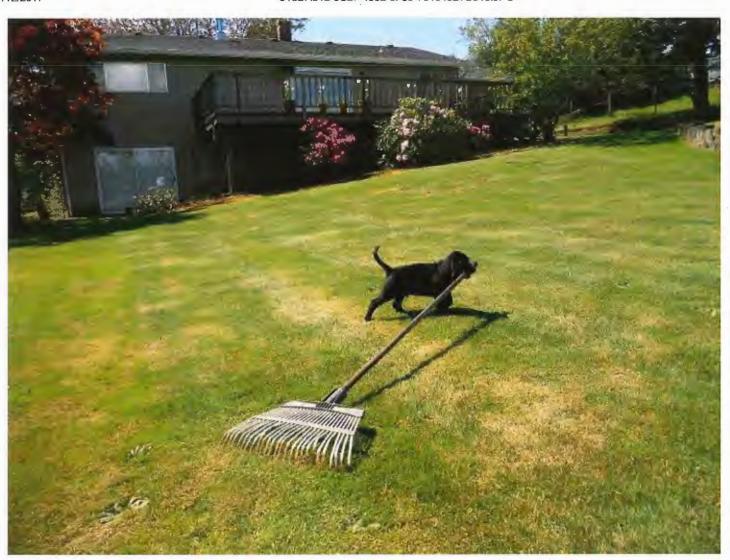

183 SQ. FT. ADDITION FOR A NEW LAUNDRY ROOM AND MILD ROOM INTERIOR ALTERATIONS AT EXISTING KITCHEN, LIVING, AND ENTRY

PROJECT TEAM

OWNERS

JIM AND CAMILLE GREENSLADE TROUTDALE, OREGON 97060 CONTACT: JIM GREENSLADE

DESIGNER

1332 SE 44TH AVE. PORTLAND OREGON 97215 CONTACT: CHUCK COHEN TFI: 503 320 8090

STRUCTURAL ENGINEER

HORN CONSULTING ENGINEERS PORTLAND OR 97219 TEL: 503.892.5782

GENERAL CONTRACTOR

OWNER/ BUILDER: JIM GREENSLADE TROUTDALE, OREGON 97060 CONTACT: JIM GREENSLADE

BUILDING DATA

BUILDING CODE:

2014 OREGON RESIDENTIAL SPECIALTY CODE (ORSC) 2014 OREGON ENERGY EFFICIENCY SPECIALTY CODE

CONSTRUCTION TYPE:

TYPE V B

OCCUPANCY TYPE: BUILDING AREA:

EXISTING MAIN LEVEL HABITABLE AREA: 1,576 S.F. EXISTING BASEMENT LEVEL HABITABE AREA: 1,101 S.F. NEW MAIN LEVEL HABITABLE AREA: 183 S.F.

2,860 S.F.

1,142 S.F. / 2,860 S.F. = 40%

INTERIOR ALTERATIONS AREA: MAIN LEVEL VAULTED CEILING AREA:

INTERIOR ALTERATIONS NEW ADDITION

959 S.F. 183 S.F. 1,142 S.F.

VAULTED AREA / TOTAL HABITABLE AREA:


SHEET INDEX

ARCH	TECTURAL	STRUC	TURAL
A0.0	COVER SHEET, GENERAL NOTES	SO	STRUCTURAL NOTES SHEAR WALL SCHEDULE
A1.1	SITE PLAN EXISTING NEW BASEMENT LEVEL FLOOR PLAN	\$1.1	FOUNDATION PLAN
A1.2 A2.2	EXISTING/ DEMOLITION MAIN LEVEL FLOOR PLAN NEW MAIN LEVEL FLOOR PLAN	\$1.2	FLOOR FRAMING PLAN
A3.1	BUILDING SECTIONS	\$1.3	ROOF FRAMING PLAN
A4.1	ROOFPLAN	\$2.1 \$2.2	DETAILS DETAILS
A5.1 A5.2	EXTERIOR ELEVATIONS EXTERIOR ELEVATIONS	52.2	DEINIG

INTERIOR ELEVATIONS INTERIOR ELEVATIONS

NEW REFLECTED CEILING PLAN W/ POWER & SWITCHING

VICINITY MAP

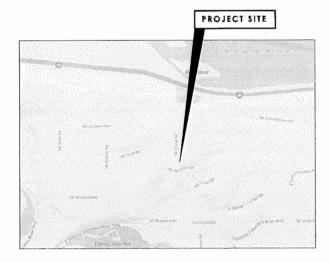

PRESCRIPTIVE PATH ENERGY DATA

FLAT CEILINGS: NOITA ILIZNI NIM 8E-R

VAULTED CEILINGS: R-30 MIN, INSULATION (WHERE VAULTED AREA < THAN 50% OF

HABITABLE FLOOR AREA)

WOOD FRAMED WALLS: R-21 MIN. LINDER ELOORS R-30 MIN. DUCT INSULATION: R-8 MIN

ENTRY DOORS: U - 0.20 U -0 .35 WINDOWS:

SEE BUILDING SECTIONS FOR OTHER INSULATION INFO

DEFERRED SUBMITTALS

ELECTRICAL: PHIMBING HVAC:

BIDDER DESIGNED BIDDER DESIGNED BIDDER DESIGNED **GENERAL NOTES**

ALL EXTERIOR DIMENSIONS ON PLANS ARE FROM FACE OF CONCRETE, FACE OF STUD, CENTERLINE OF COLUMN, OR CENTERLINE OF OPENING UNLESS NOTED OTHERWISE. ALL INTERIOR DIMENSIONS ARE FROM FACE OF FINISH MATERIAL.

THE GENERAL CONTRACTOR SHALL BE RESPONSIBLE FOR COMPLYING WITH ALL BUILDING CODES, DRIBANCES AND REGULATIONS GOVERNING THE WORK FOR THIS PROJECT, NOTHING IN THESE PLANS OR NOTES SHALL BE CONSTRUED TO PERMIT WORK NOT ACCORDING TO CODE.

THE GENERAL BUILDING PERMIT SHALL BE ACQUIRED BY THE GENERAL CONTRACTOR. ALL REQUIRED TRADE PERMITS SHALL BE ACQUIRED AND PAID FOR BY THE INDIVIDUAL TRADE.

5. ALL CONTRACTORS SHALL BE HELD RESPONSIBLE TO HAVE VERIFIED ALL DIMENSIONS AND EXISTING CONDITIONS BEFORE FFOCEEDING WITH THE WORK, ANY ERRORS, OMSSIONS, DISCREPANCIES OR QUESTIONABLE ITEMS IN THE DRAWINGS OR SPECIFICATIONS SHALL BE IMMEDIATELY BROUGHT TO THE DESIGNER'S ATTENTION BEFORE CONSTRUCTION BEGINS.

6. BEFORE SUBMITING ANY PROPOSAL, IT SHALL BE THE RESPONSIBILITY OF the GENERAL CONTRACTOR TO FAMILIARIZE HIMSELF WITH ALL CONDITIONS AT THE SITE RELATIVE TO DISTING WORK, MATERIALS TO BE TO MATCHED, WORKING SPACE AVAILABLE, ACCESS, AND OTHER ASPECTS AFFECIMED THE SCOPE OF THE WORK TO THE MAKING OF AN INFORMACE BID, ON INCREASE WE COST OR RESPONSION IN PERFORMANCE TIME WILL BE CONSIDERED TO REALLY FOR THE WORK TO THE MAKING OF AN INFORMACE BID, WILL BE CONSIDERED TO REALLY THE MAKING OF THE MAKING OF THE WORK OF THE MAKING OF TH

7. THE GENERAL CONTRACTOR SHALL COORDINATE ALL

B. THE GENERAL CONTRACTOR SHALL MAINTAIN A FULL SET OF DRAWINGS AND SPECIFICATIONS ON THE JOB SITE AT ALL TIMES. THEY SHALL BE MADE AVAILABLE TO THE DESIGNER AND OWNER

THE GENERAL CONTRACTOR SHALL BE RESPONSIBLE FOR PROTECTING, PATCHING, AND REPAIRING ALL EXSTING WORL ADJACENT TO HIS WORK OR DAMAGED AS A RESULT OF HIS WORK. UNLESS OTHERWISE NOTED, ALL EXISTING WORK OR DEVICES INCLUDING THOSE NOT SHOWN ON THE DRAWING ARE TO

13. DISCREPANCY BETWEEN SPECIFICATIONS IN ARCHITECTURAL DRAWINGS & STRUCTURAL DRAWINGS SHALL BE BROUGHT TO THE ATTENTION OF THE ARCHITECT AND RESOLVED PRIOR TO PROCEEDING WITH THE WORK AFFECTED BY THE DISCREPANCY.

LARGER SCALE DRAWINGS GOVERN OVER SMALL SCALE DRAWINGS.

THE GENERAL CONTRACTOR SPALL FURNISH A WHITEN GUARANIEE FOR ALL WORK FOR A PERIOD OF ONE YEAR FROM THE DATE OF COMPLETION AS EVIDENCED BY FINAL PAYMENT. THE GENERAL CONTRACTOR SHALL MAKE NECESSARY REPAIRS AT NO ADDITIONAL COST UPON RECEIPT OF FORMAL NOTICE FROM

19. IT IS THE RESPONSIBILITY OF THE GENERAL CONTRACTOR TO SECURE THE PREMISES AT THE END OF EACH WORKING DAY. DOOR OPENINGS AND WINDOW PPENINGS, SHALL BE PROTECTED WITH PLYWOOD SHEETING OR OTHER APPROVED MEANS UNITL SECURITY LOCKS ARE IN PLACE. OTHER WALL OPENINGS SHALL BE TEMPORARITY COVERS WITH PLYWOOD.

THE GENERAL CONTRACTOR SHALL CLEAN THE SITE OF LOOSE DEBRIS AT END OF EACH WORK DAY.

ABBREVIATIONS

PENNY (AS NAIL 10D) DEGREE DIAMETER DIMENSION

11. IN THE CASE OF DISCREPANCIES BETWEEN THE DRAWING AND SPECIFICATIONS, THE REQUIREMENTS SET FORTH IN THE SPECIFICATIONS SHALL PREVAIL DISCREPANCIES, IF ANY, SHALL BE BROUGHT TO THE ARCHITECTS ATTENTION BEFORE PERFORMING

12. THE GENERAL CONTRACTOR SHALL VERIFY ALL DIMENSIONS PRIOR TO STARTING CONSTRUCTION AND ORDERING MATERIALS. IN THE CASE OF A DISCRET MONY SERVER DIMENSIONS ON DRAWINGS AND ACTUAL EXISTING CONDITIONS IN THE PILED, THE DISCRETANCY SHALL BE REQUESTED TO THE ATTRICTION OF THE PILED AND ACCORDING TO THE ATTRICTION OF THE ACCORDING AND ACCORDING TO THE ATTRICTION OF THE MORK APPECIATED BY THE DISCRETANCE PERFORMING THE WORK

DETAILS MARKED TYPICAL' SHALL APPLY IN ALL CASES, UNLESS SPECIFICALLY NOTED OTHERWISE. WHERE NO DETAIL IS SHOWN, CONSTRUCTION SHALL BE AS SHOWN FOR OTHER SIMILAR WORK.

IN NO INSTANCE SHALL WORKING DIMENSIONS BE SCALED FROM PLANS OR DETAILS. FIGURES ON DRAWINGS GOVERN, AND

16 THE GENERAL CONTRACTOR SHALL FURNISH A WRITTEN

17. THE CONTRACTOR SHALL ADEQUATELY SHORE ALL EXSTING CONSTRUCTION FOR WHICH THE SUPPORT IS REMOVED UNTIL ALL NEW SUPPORTS ARE IN PLACE. WHIERE WALLS ARE REMOVED WHICH PROVIDE LATERAL SUPPORT FOR THE BUILDING, EITHER A SEQUENCE OF CONSTRUCTION SHALL BE FOLLOWED WHICH SEQUENCE OF CONSINUCTION SHALL BE FOLLOWED WHILE
ALLOWS LATERAL FORCES TO BE SUPPORTED BY NEW WALLS
PRIOR TO REMOVAL OF EXISTING WALLS OR ADEQUATE
TEMPORARY BRACING SHALL BE PROVIDED UNTIL NEW
CONSTRUCTION IS IN PLACE.

ANCHOR BOLT LAMINATE(D) POUND POUNDS ACOUSTICAL CEILING PANEL ADJUSTABLE ABOVE FINISH FLOOR ANCHOR LINEAR FOOT (FEET AMERICAN WIRE GAUGE BUILT UP ROOFIN CUBIC FEET MANUFACTURER MISCELLANEOUS CAST IN PLACE CONTROL JOINT NEW NOT APPLICABLE CONCRETE MASONRY UNIT PERPENDICULAR PLATE PLASTIC LAMINATE

PLYWD PNL PREFAB PLYWOOD PANEL EXISTING
EACH
EXPANSION BOLT
EACH END
EXPANSION JOINT

ELECTRIC(AL) REQ(D) EACH WAY

EXTERIOR

FINISH FLOOR FLUOR FLUORESCENT FACE OF FACE OF CONCRETE FACE OF FINISH FACE OF MASONRY FACE OF MASO FACE OF STUD FACE OF WALL FEET (FOOT) FOOTING

HEATING VENT & AIR CONDITIONING INSIDE DIAMETER

GLUE LAMINATED TIMBER

GYPSUM WALL BOARD

HANDICAP

HEADER

PREFABRICATED POUNDS PER SQ. FT. POUNDS PER SQ. INCH REQUIRE(D) SMOKE DETECTOR SQUARE FOOT

SHATHING SIMILAR SQUARE STAINLESS STEEL SOUND TRANSMIS тор & воттом

TONGUE & GROOVE TEMPERED - TEMPORARY TUBE \$TEEL TOP OF TYP TYPICAL

INDERGROUND

WITHOUT WELDED WIRE FABRIC

SYMBOLS

wall section

--- DETAIL SECTION



EXTERIOR OPENING NUMBER SEE ELEVATION

-- ROOM NAME

-- ROOM NUMBER

DOOR NUMBER





MATERIAL LEGEND

GRAVEL SAND CONCRETE \bowtie

WOOD (FRAMING/BLOCKING LARGE SCALE) WOOD (NON-CONTINUOUS BLOCKING LARGE SCALE) WOOD (TRIM/FINISH CONCRETE MASONRY IINIT

THE POST OF THE PARTY OF THE PA STEEL LARGE SCALES



GYPSUM WALL BOARD LARGE SCALE BATT INSULATION RIGID INSULATION

ACOUSTICAL TILE LARGE SCALE

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Portland, OR 97215

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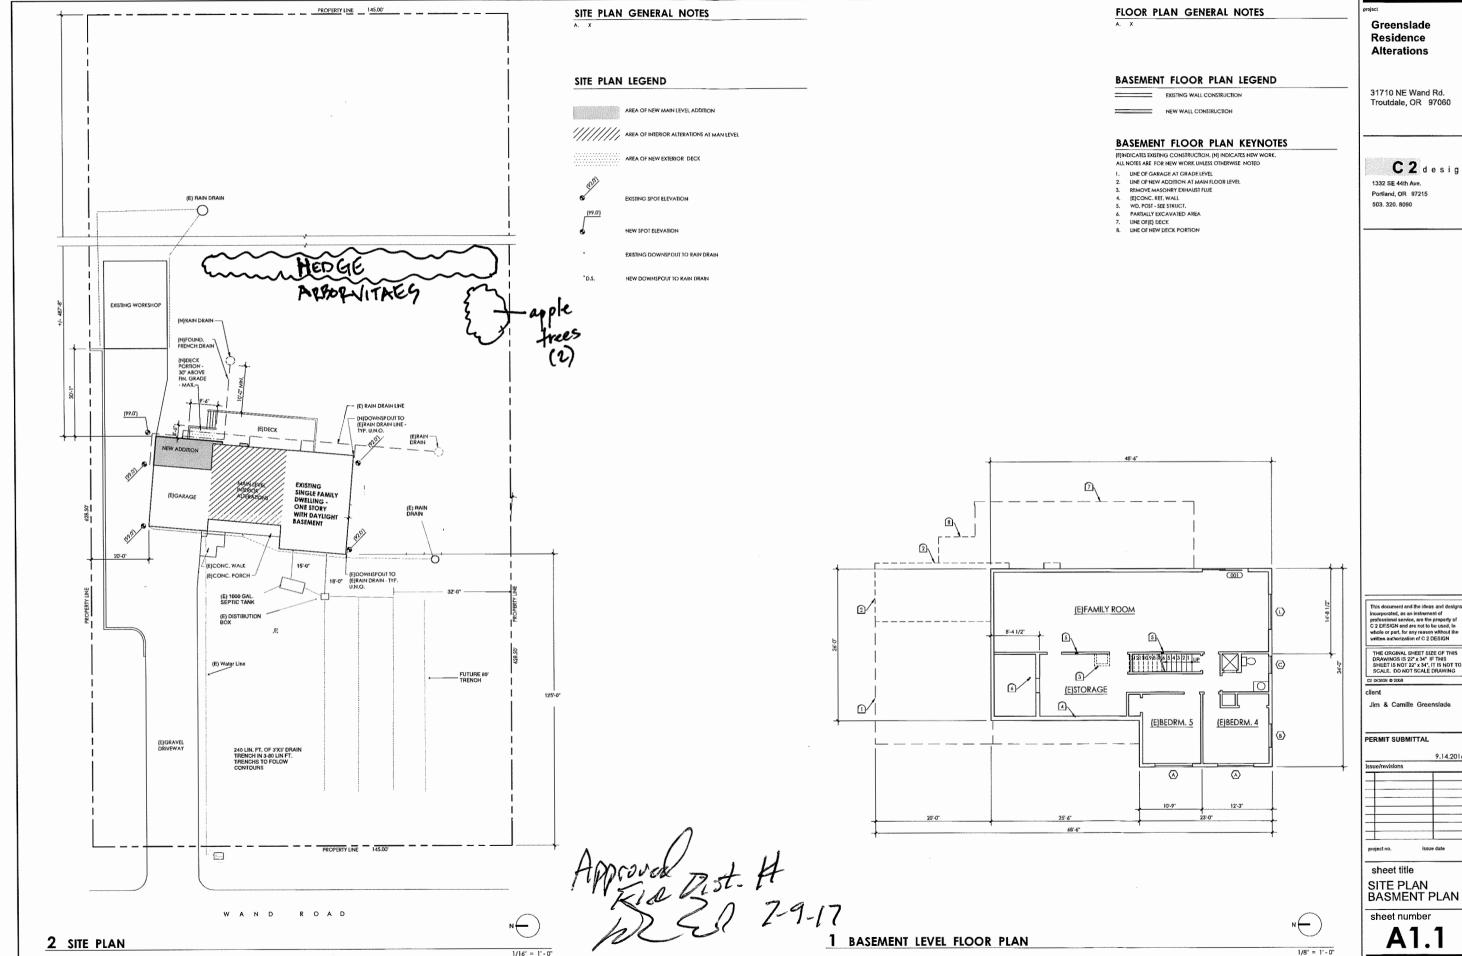
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sheet title TITLE SHEET GEN. NOTES

sheet number

A0.0



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A1.1

DEMOLITION PLAN GENERAL NOTES

- A. FIELD VERIFY BEARING CONDITION OF EXISTING WALLS PRIOR TO REMOVAL
- B. ALL EXISTING WINDOW ASSEMBLIES TO BE REMOVED & REPLACED WITH NEW WINDOW ASSEMBLIES

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EXISTING WALL CONSTRUCTION

[호] 궁 CONSTRUCTION ELEMENT TO BE REMOVED ----

KEYNOTE

DEMOLITION PLAN KEYNOTES

(E) INDICATES EXISTING CONSTRUCTION, [IN] INDICATES NEW CONSTRUCTION, ALL NOTES ARE FOR NEW WORK UNLESS OTHERWISE NOTED.

LEGEND

- 1. REMOVE WALL
 2. REMOVE DOOR ASSEMBLY
 3. REMOVE CASEWORK TYP.
 4. REMOVE SINK
 5. LINE OF ROOF

- 6. REMOVE SLIDING GLASS DOOR ASSEMBLY
 7. REMOVE WINDOW ASSEMBLY
 8. REMOVE EXHAUST SHAFT ENCLOSURE
- 9. REMOVE DECK GUARDRAIL FOR NEW DECK EXTENSION

- 10. BM. ABOVE
 11. REMOVE WALL PORTION FOR NEW WINDOW ASSEMBLY
 12. REMOVE DISHWASHER
 13. NOT USED

- 14. ROUGH WINDOW OPENING TO BE MODIFIED FOR NEW WINDOW ASSEMBLY
 15. ROUGH WINDOW OPENING TO BE MODIFIED FOR NEW WINDOW ASSEMBLY

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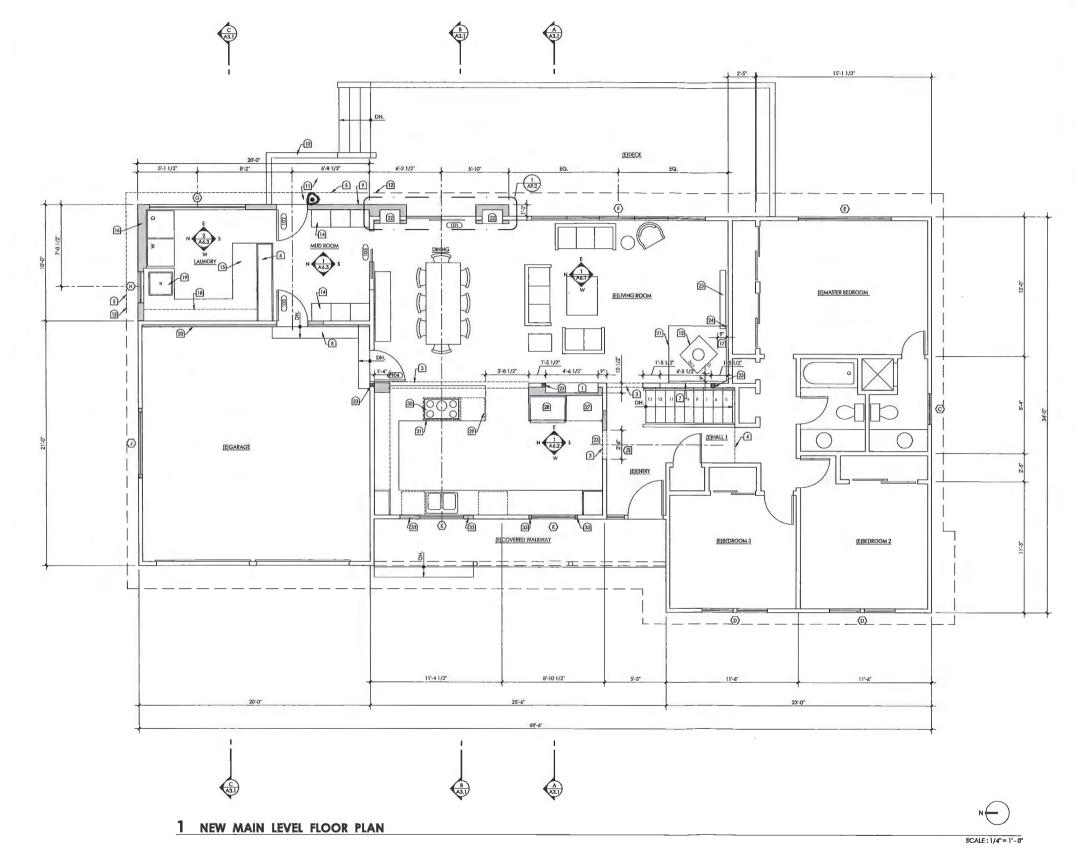
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sheet title

MAIN LEVEL DEMOLITION PLAN

sheet number

A1.2



NEW FLOOR PLAN GENERAL NOTES

B. INIDCATED EXTERIOR DIMESNIONS ARE FROM F.O. STUD OR F.O.

LEGEND

NEW WALL CONSTRUCTION

NEW MAIN LEVEL FLOOR PLAN KEYNOTES

(E)INDICATES EXISTING CONSTRUCTION. (N) INDICATES NEW WORK.
ALL NOTES ARE FOR NEW WORK UNLESS OTHERWISE NOTED

- BUILT-I SHELVING SEE INT. ELEV.
- CENTERUNE OF SLIDING GLASS DOOR, COOKTOP, AND WINDOW BEAM ABOVE-SE INT. ELEV.
- LINE OF CEILING HT. CHANGE

- UNE OF CEUING HT. CHANGE
 LINE OF HEMP ROOF ASSEMBLY
 CARNERY COAT AND PANIRLY STORAGE SEE INT, ELEY,
 NEW WALL OPENING SEE INT ELEY, FOR INFO.
 1 TREAD [10" MIN.] & 2 RISERS (8" EACH MAX.) MATCH DIMENSIONS & MATERIAL
- OF ADJACENT STEP
 WALL ASSEMBLY 2 x 6 WD. STUD @ 16" O.C. W/ FIBERGLASS BATT INSUL. SEE
- BUILDING SECTION

 10. DECK GUARDRAIL +36" ABOVE FIN. DECK WHERE FIN. DECK > 30" ABOVE FIN.
- GRADE 4" CLEAR MAX. BETWEEN BALUSTRADES
- 11. DECK PORTION TO MATCH EXISTING -T.O. FIN. DECK TO BE LESS THAN 30" ABOVE FIN. GRADE

 12. LINE OF [EJROOF

 13. WOOD STOVE HEATER

 14. BENCH SEAT W/ SHOE STORAGE BELOW

- 16. COUNTER TOP © +36" W/ \$10RAGE BELOW

 16. FURR OUT WALL W/ 2 x 4 WD. \$TUD TO ACCOMMODATE WASHER BOX & DRYER

 17. DRYEN OUT WALL W/ 2 x 4 WD. \$TUD TO ACCOMMODATE WASHER BOX & DRYER

 18. COUNTER TOP © +36" W/ \$10RAGE BELOW
- 17. PROVIDE CLEARANCE PER MFR.'S REQUIREMENTS
- 18. UNE OF UPPER CABINETS

 19. LAUNDRY SINK 2'-0" x 2'-0"
- 20. WALL FURRING 2 x 2 TO [E] 2 X 4 STUDS TO ACCOMODATE R-21 BATT INSUL.
 21. NON-COMBUSTIBLE HEARTH
 22. BUILT-IN CABINETRY/ SHELVING FOR WINE STORAGE PROVIDE CLOSED INSUL. AT
- EXTERIOR WALLS SEE INTERIOR FLEVS., DETAILS
- EXTERIOR WALLS SEE INTERIOR ELEVS., DETAILS

 2. CENTRE WALL OPENING ON HALL I CENTERLINE

 24. MASONRY SURROUND TO 36" AFF, FLYERIFY W/ MFR'S. REQUIREMENTS)

 25. LOCATION FOR FLAT SCREEN T.V.

 26. FIN. OPENING WIDTH

 27. PARITY

 28. REFRIGERATIOR / FRECEIR

 29. REFRIGERATIOR RECEIR

- 29. BELOW COUNTER MICROWAVE
- 30. COOKTOP (3'-0" x ± 2'-0")
- 31. LINE OF HOOD ABOVE 32. NOT USED
- 33. NEW WALL PORTION &EA. SIDE OF NEW WINDOW ASSEMBLY



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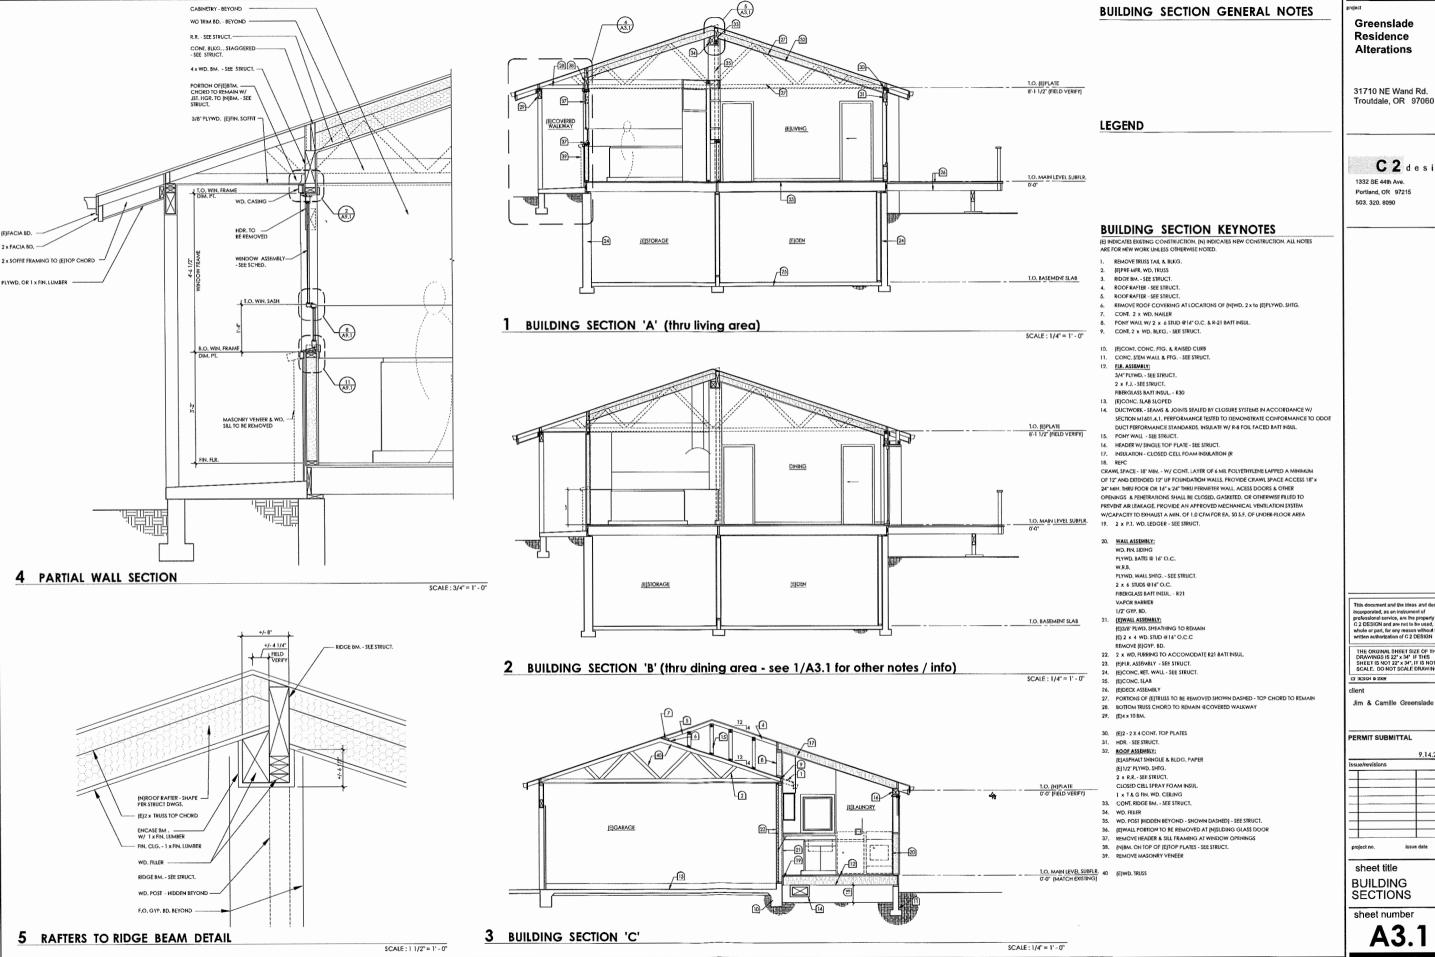
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NEW MAIN LEVEL FLOOR PLAN

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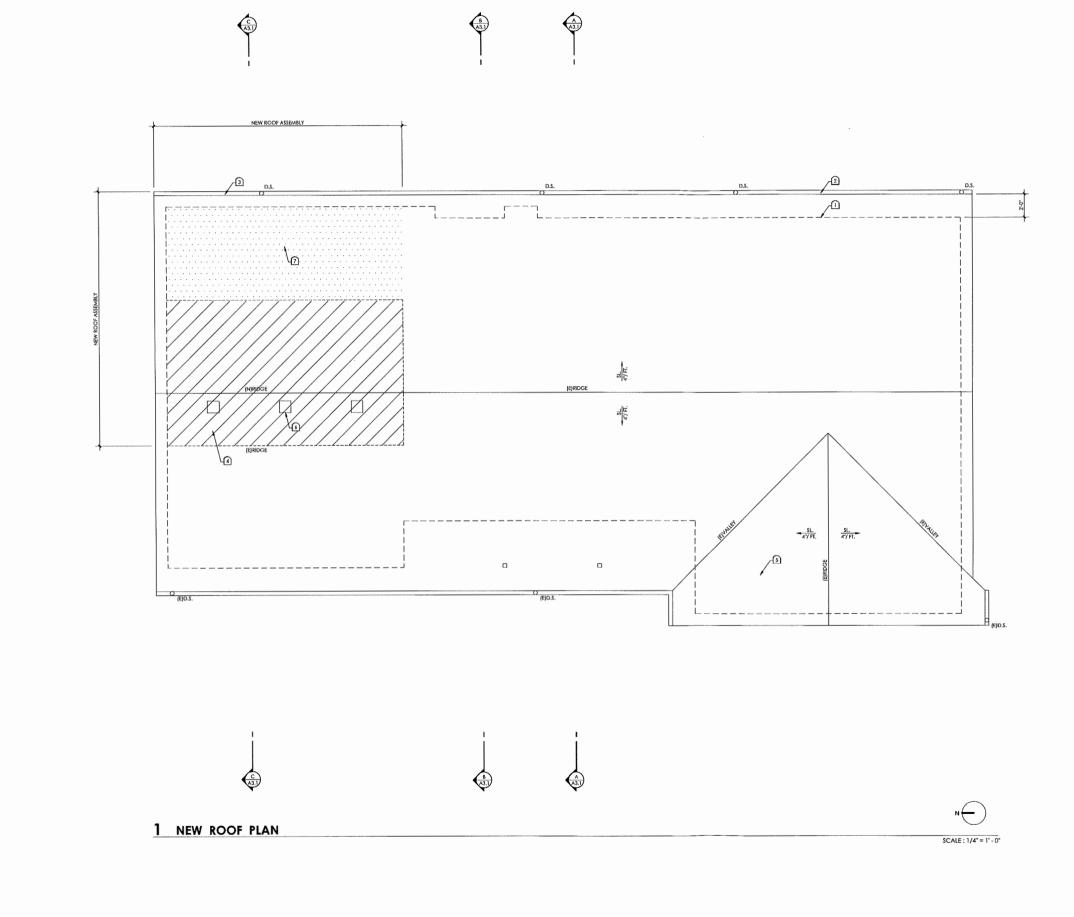
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sheet number

A3.1

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NEW ROOF PLAN GENERAL NOTES

A. PROVIDE ROOF VENTING FOR NEW OVERFRAMED AREA AT EXISTING GARAGE AND EXISTING GARAGE ATTIC AREA

B. THE NET FREE VENT AREA (NPVA) SHALL NOT BE LESS THAN 1:150
OF THE AREA OF THE SPACE BEING VENTED, THE NET FREE
VENTILATION MAY BE REDUCED FROM 1:150TO 1:300 WHEN AT
LEAST 40 PERCENT BUT NOMORE THAN 50 PERCENT OF THE
REQUIRED VENTILATIONAREA IS PROVIDED AT OR NEAR THE
UPPER PORTION OF THE SPACE BRING VENTILATED.

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Alterations

LEGEND

EXISTING DOWNSPOUT

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NEW ROOF PLAN KEYNOTES

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- ALL NOTES ARE FOR NEW WORK UNIESS OFFERWEE NOTED

 LINE OF BLODG AT MAIN LEVEL BELOW

 [ESHIT, MIL. GUTTER & (B) DOWNSFOUT (PREPAINTED)

 SHI. MIL. GUTTER & (B) DOWNSFOUT (PREPAINTED)

 [EJOVEERRAMING AREA OVER (EJRODG ASSEMBLY

 [EJOVEERRAMING AREA

 6. ROOF VENT SEE ROOF PLAN GENERAL NOTES

 VAULTED CELINGS AREA W/ CLOSED CELL INSULATION IN RAFTER

 CAVITIES NO EXTERIOR VENTILATION PROVIDED

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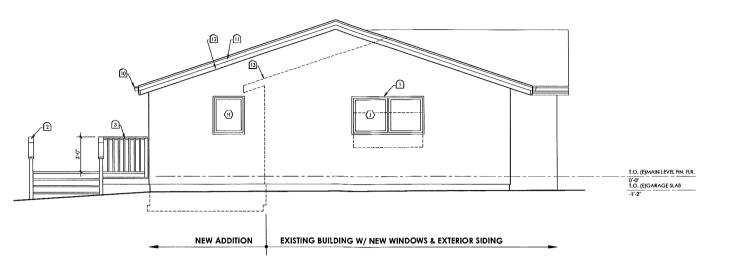
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sheet title NEW ROOF PLAN


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A4.1



1 NORTH ELEVATION

SCALE: 1/4" = 1' - 0"

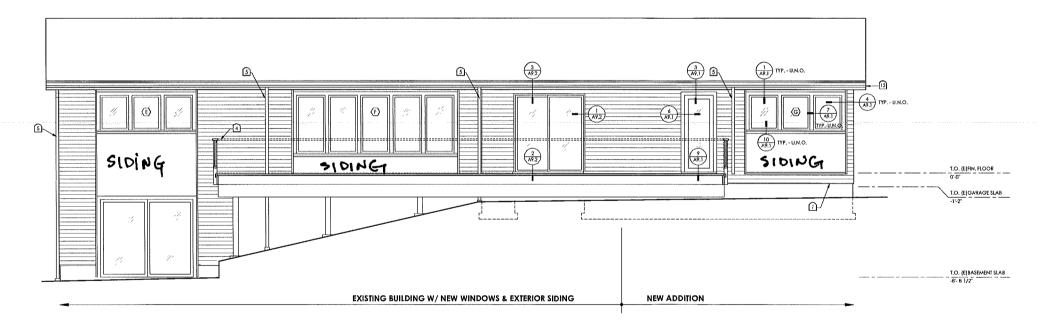

2 EAST ELEVATION

SCALE: 1/4" = 1' - 0"

Siding = hardi-plank style WINDOWS WILL have a reflectivity rating of 13% or kss.

EXTERIOR ELEVATION GENERAL NOTES

LEGEND

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- 1. RELOCATE WINDOW OPENING ALIGN WINDOW HEAD W/ HEAD OF LAUNDRY RM. WINDOW - MAINTAIN ROUGH OPENING WIDTH
- (E) GUARDRAIL ASSEMBLY & STAIRCASE ASSEMBLY
- GUARDRAIL ASSEMBLY PORTION +36" ABOVE FIN, DECK 4" MAX, CLEAR BETWEEN BALUSTRADES
- UNE OF [E)GUARDRAIL ASSEMBLY BEHIND POINT OF VIEW FOR ELEVATION
 (N) DOWNSPOUT LOCATION
- 6. DOWNSPOUT
- AUGN BOTTOM OF SIDING W/ BOTTOM OF SIDING ON NORTH ELEVATION 8 NOT USED
- 9. (N)WINDOW ASSEMBLY TO REPLACE (E)WINDOW ASSEMBLY IN (E)WINDOW ROUGH OPENING - TYP.
- 10. (E) GUTTER
- 12. FASCIA BD. SEE BUIDLING SECTION 13. LINE OF (E)BLDG.
- 14. (E) WINDOW OPENING TO BE MODIFIED

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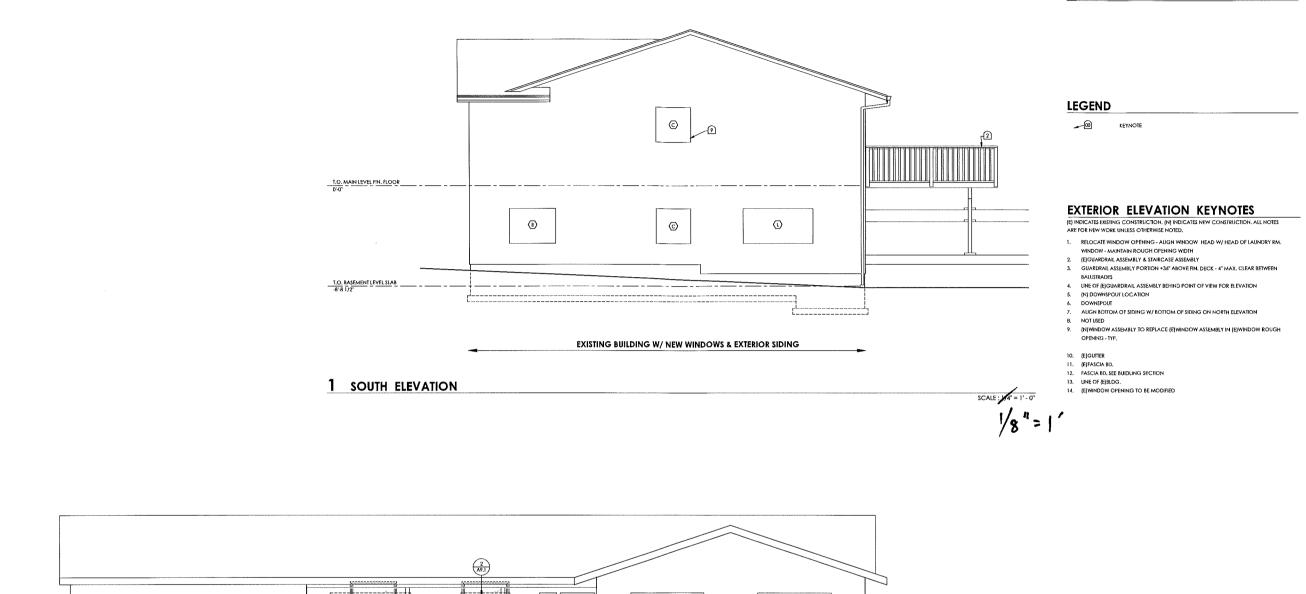
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EXTERIOR ELEVATIONS

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A5.1



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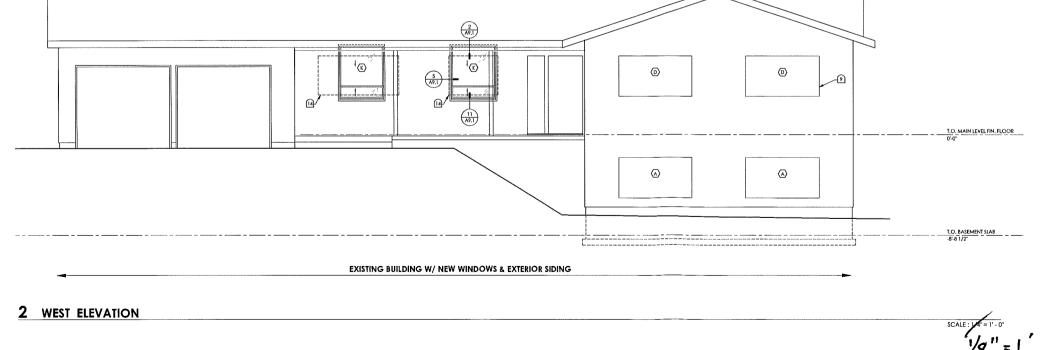
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EXTERIOR ELEVATIONS

sheet number

A5.2



1 LIVING | DINING ROOM INTERIOR ELEVATIONS

INTERIOR ELEVATION GENERAL NOTES

INTERIOR ELEVATION KEYNOTES (E) INDICATES EXISTING CONSTRUCTION, (N) INDICATES NEW CONSTRUCTION, ALL NOTES ARE FOR NEW WORK UNLESS OTHERWISE NOTED.

DBL HUNG WINDOW WITH UNEVEN SASH SIZES - MODIFY OPENING HEAD & SILL AS REQ'D.

DBL. HUNG WINDOW WITH UNEVEN SASH SIZES - MODIFY OPENING HEAD, SILL, & WIDTH AS REQ'D.

ASSUMED EXISTING HEADER LOCATION, VERIFY LOCATION PRIOR TO ORDERING WINDOWS

9. CABINET COMPARTMENT FOR BAKING SHEETS AND TRAYS

14. AUGN T.O. CABINETRY W/ T.O. WINDOW CSING AND/ OR DOOR CASING 15. BACKSLPASH - MATERIAL & HT. TO BE DETERMINED

17. UPHOLSTERED CUSHION AT BENCH & BENCH BOX

WALL CAP FOR FURRED OUT HALF WALL BELOW, P.LAM. OVER 1'MARINE PLYWD, W/ SELF EDGING OR OTHER MATERIAL TO BE DETERMINED

5. ROUGH FRAMING ENCASED W/ FIN. LUMBER

7. RIDGE BM. ENCSED W/ FIISHED LUMBER B. UNE OF BUILT-IN SHELVING BEYOND

4. CERAMIC OR STONE TILE

10. MICROWAVE IN A DRAWER 11. WD. SHELVING - +/- 12" DEEP 12. OPEN SHELVING 13. GYP, BD, SOFFIT OVER CABINETRY

16. OPEN COMPARTMENT - TYP.

18. WASHER BOX - RECESSED

20. WALL PORTION TO BE FURRED OUT 21. WALL PORTION W/O WALL FURRING

6. WD. TRIM. BOARD

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SCALE: 1/2" = 1' - 0"

Ð/ <u>o</u>/ (2) OPEN

1 LIVING | DINING ROOM INTERIOR ELEVATIONS (continued)

SCALE : 1/2" = 1' - 0"

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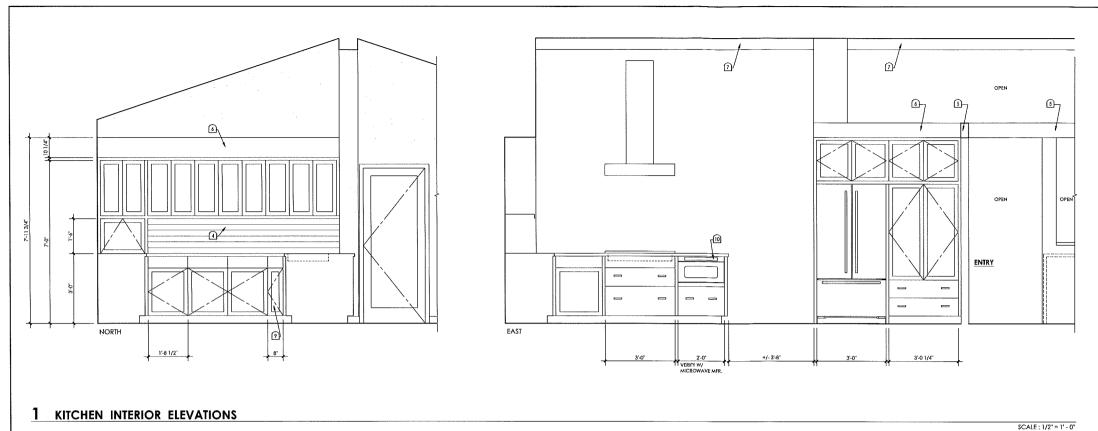
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sheet title INTERIOR ELEVATIONS

sheet number

A6.1



INTERIOR ELEVATION GENERAL NOTES

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INTERIOR ELEVATION KEYNOTES

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- D8L. HUNG WINDOW WITH UNEVEN SASH SIZES MODIFY OPENING HEAD & SILL AS REQ'D.
- DBL. HUNG WINDOW WITH UNEVEN SASH SIZES MODIFY OPENING HEAD, SILL, & WIDTH AS REQ'D.
- ASSUMED EXISTING HEADER LOCATION, VERIFY LOCATION PRIOR TO ORDERING WINDOWS
- 4. CERAMIC OR STONE TILE
- 5. ROUGH FRAMING ENCASED W/ FIN. LUMBER 6. WD, TRIM, BOARD
- 7. RIDGE BM. ENGSED W/ FIISHED LUMBER
- 8. LINE OF BUILT-IN SHELVING BEYOND
- 9. CABINET COMPARTMENT FOR BAKING SHEETS AND TRAYS
- 10. MICROWAVE IN A DRAWER 11. WD. SHELVING - +/- 12" DEEP
- 12. OPEN SHELVING
- 14. AUGN T.O. CABINETRY W/ T.O. WINDOW CSING AND/ OR DOOR CASING
- 15. BACKSLPASH MATERIAL & HT. TO BE DETERMINED 16. OPEN COMPARTMENT - TYP.
- 17. UPHOLSTERED CUSHION AT BENCH & BENCH BOX
- 18. WASHER BOX RECESSED
- WALL CAP FOR FURRED OUT HALF WALL BELOW, P.LAM. OVER I' MARINE PLYWD, W/ SELF EDGING OR OTHER MATERIAL TO BE DETERMINED
- 20. WALL PORTION TO BE FURRED OUT
- 21. WALL PORTION W/O WALL FURRING

OPEN (5) **B**\ DINING AREA HTUO2

1'-10 3/4" 1'-10 3/4" (2) (A9.1) 3 8 A9.1 2 (11) (A9.1) ENTRY WEST

1 KITCHEN INTERIOR ELEVATIONS (continued)

SCALE: 1/2" = 1' - 0"

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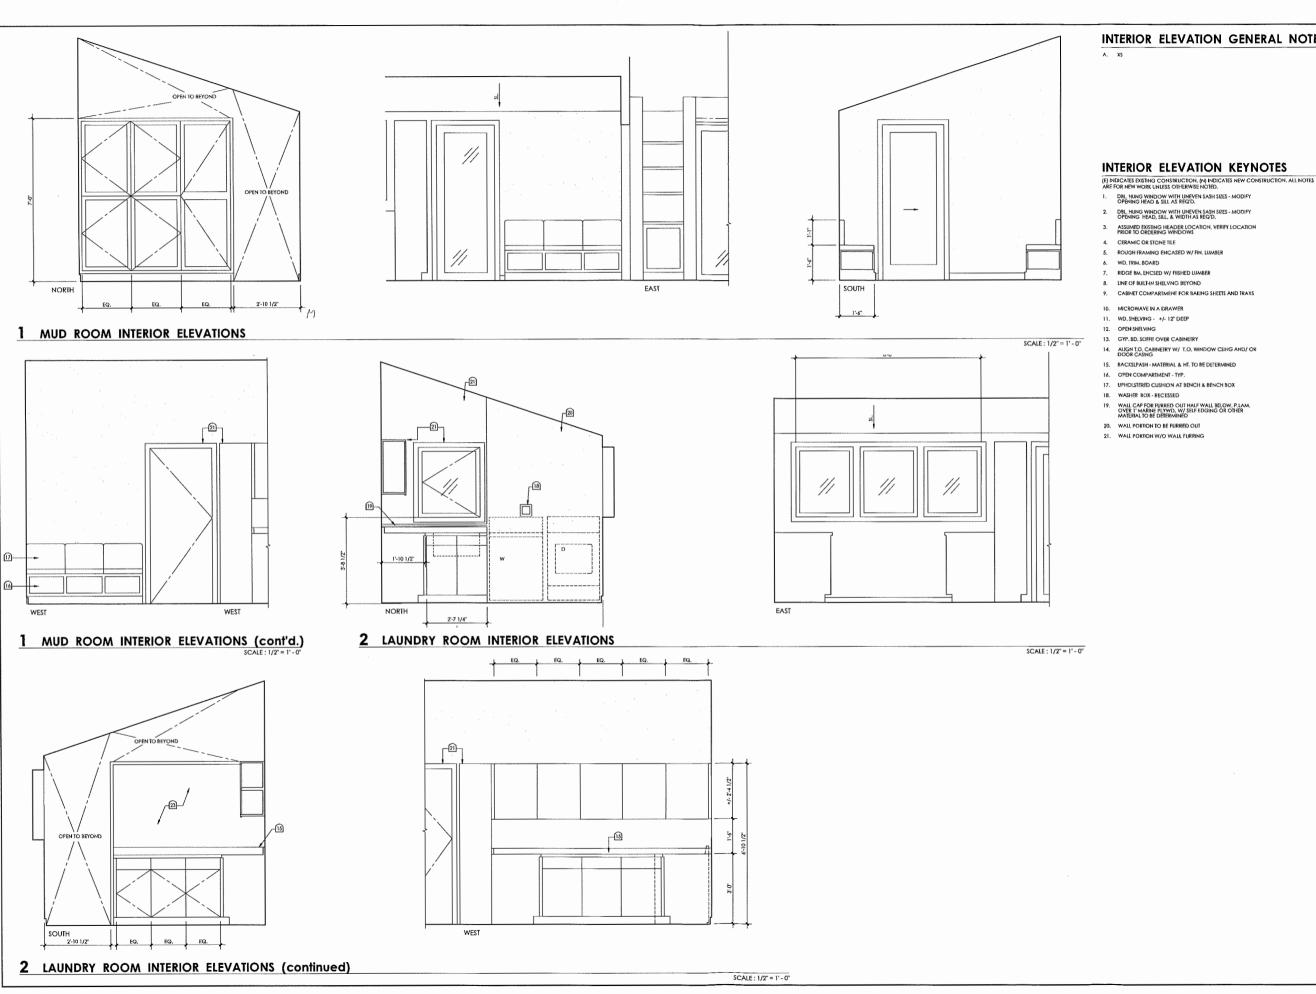
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INTERIOR ELEVATIONS

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A6.2



INTERIOR ELEVATION GENERAL NOTES

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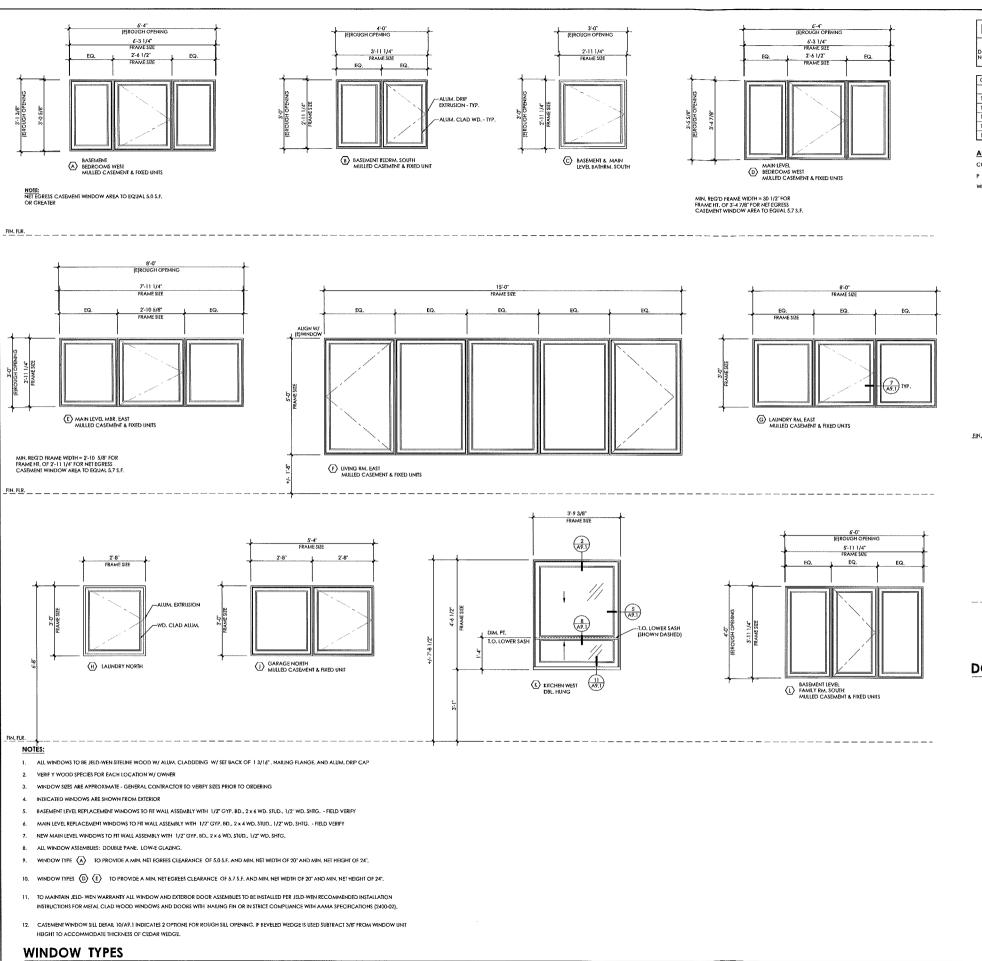
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sheet number

A6.3



DOOR SCHEDULE

DOOR NO.	DOOR SIZE WIDTH x HT.	TYPE	MATL.	FIN.	TYPE	MATL.	FIN.	HEAD	JAMB	ALT JAMB	SILL		NOTES
	0101 1107		1444	1									
001	8'-0" x 6'-8"	t	WD	P			P						1,5
101	6'-0" x 6'-8"	Е	WD	СС	·	-	СС	3/A9.2	1/A9.2	-	2/A9.2	-	1,6
102	2'-8" x 6'-8"	D	WD	cc	-	-	cc	3/A9.2	6/A9.2	-	9/A9.2	-	1,7
103	2'-8" x 6'-8"	D	WD	cc	-	-	cc	-	-	-	-		2,2A,3

ABBREVIATIONS: NOTES:

CC CLEAR COAT PAINT MOOD


1. WD. W/ ALUM, CLAD EXTERIOR


- PROVIDE SELF CLOSING MECHANISM ON PUSH SIDE OR SELF CLOSING HINGES
- 3. PROIVDE SMOKE SEALS & THRESHOLD
- 4. POCKET DOOR ASSEMBLY
- 5. FIELD VERIFY REQUIRED JAMB, HEAD, & SILL CONDITIONS
- 6. 4 9/16" FRAME OPTION 7. 6 9/16" FRAME OPTION

GENERAL NOTES:

A. DOOR HARDWARE TO BE SELECTED BY OWNER.

- B. SLIDING DOORS = JELD-WEN SITELINE WD. CLAD 400 (NARRO'STILE) STANDARD JAMB W/NAIL-ON FIN. WOOD; DOUGLAS FII ALUM. CLADDING COLOR; XXXX
- C. EXTERIOR SWINGING DOOR = JELD-WEN SITELINE WD. CLAD 00000 STANDARD JAMB W/NAIL-ON FIN. WOOD: DOUGLAS ALUM. CLADDING COLOR: XXXX

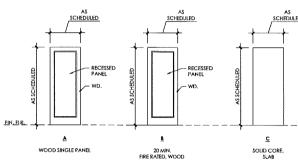

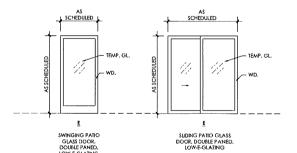

DOOR TYPES

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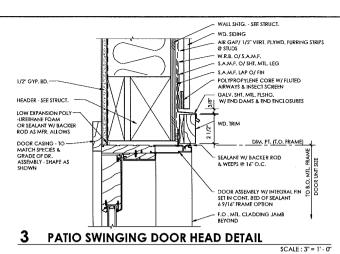
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project no.	issue date

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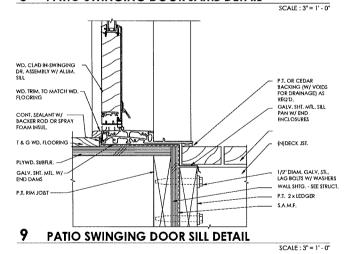
A8.1


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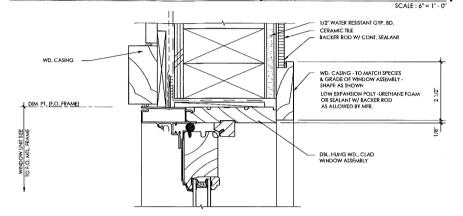
- WALL SHTG. - SEE STRUCT. 1/2" GYP. BD. - WRB - AIR GAP/ 1/2" VERT. WD. FURRING STRIPS & STUDS DOOR CASING - TO ~ MATCH SPECIES & GRADE OF DR. ASSEMBLY - SHAPE AS SHOWN _ S.A.M.F. WD. SIDING
CONT. SEALANT
WD. TRIM W/FURRING STRIP
(ATTACH TO BACK OF TRIM -DO
NOT ATTACH THRU WIND. FIN.) LOW EXPANSION POLY— -URETHANE FOAM OR SEALANT W/ BACKER ROD AS MFR. ALLOWS DIM. PT. (F.O. FRAME) DOOR ASSEMBLY W/INTEGRAL FIN SET IN CONT. BED OF SEALANT 6 9/16" FRAME OPTION SHIM SPACE

6 PATIO SWINGING DOOR JAMB DETAIL







DOUBLE HUNG WINDOW HEAD DETAIL (see 5/A9.1 for other notes / info.)

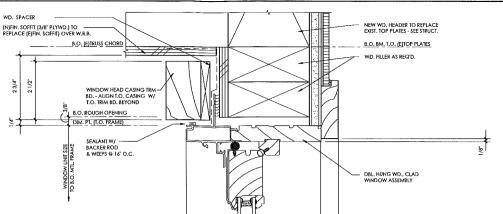


5 DOUBLE HUNG WINDOW JAMB DETAIL

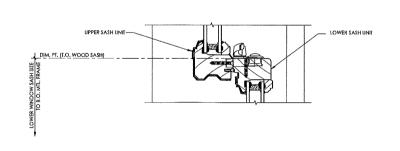

8 UPPER / LOWER SASH INTERFACE DETAIL

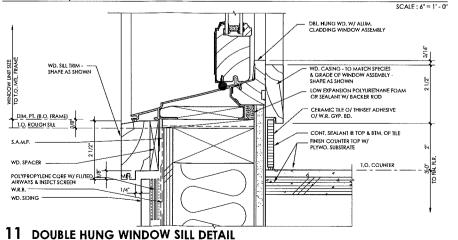

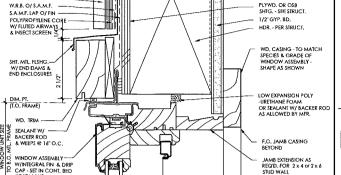



CASEMENT WINDOW HEAD DETAIL

S.A.M.F. O/SHT. MTL. LEG


SCALE : 6" = 1' - 0"

SCALE : 6" = 1' - 0"

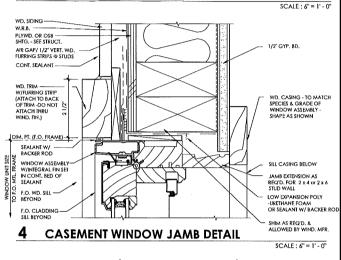

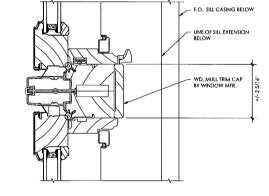

7 CASEMENT WINDOW JAMB MULL DETAIL

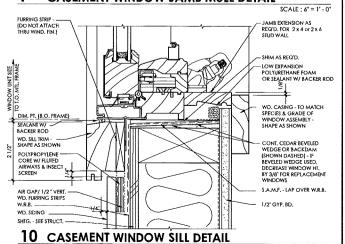

Greenslade Residence **Alterations**

31710 NE Wand Rd. Troutdale, OR 97060

C 2 design

1332 SF 44th Ave. Portland, OR 97215 503, 320, 8090

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Jim & Camille Greenslade

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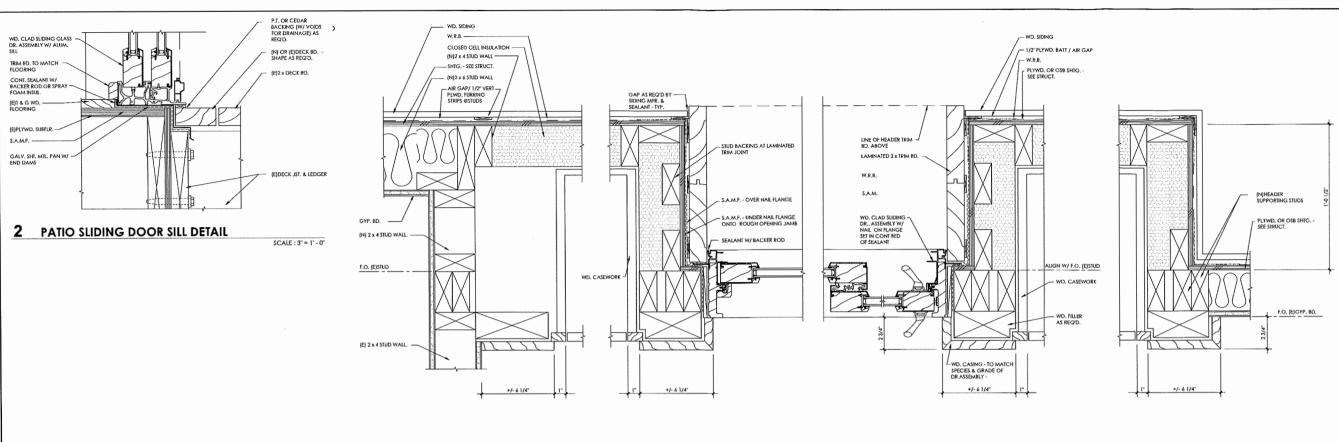


DETAILS

sheet number

SCALE : 6" = 1' - 0"

A9.1



Alterations 31710 NE Wand Rd. Troutdale, OR 97060

Greenslade

Residence

C 2 design 1332 SE 44th Ave. Portland, OR 97215

503. 320. 8090

SCALE: 3" = 1' - 0" T.O. (E)DBL. TOP PLATE HDR. - SEE STRUCT. 2 x SOFFIT FRAMING - (E)FASCIA BD. 2 x WD. FASCIA BD. PLYWD. SOFFIT BD. WD, SIDING

AIR GAP/ 1/2" PLYWD, VERT, FURRING STRIPS S.A.M.F. LAPPED OVER VERT. LEG - OF SHT. MTL, FLASHING S.A.M.F. J SEALANT W/ BACKER ROD & WEEPS @ 16" O.C. SEALANT W/ BACKER ROD & WEEPS @ 16" O.C. LAMINATED 2 x TRIM BD. --DOOR ASSEMBLY W/INTEGRAL FIN SET IN CONT, BED OF SEALANT 69/16" FRAME OPTION

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sheet number

A9.2

1 PATIO SLIDING DOOR JAMBS AND ADJACENT CASEWORK DETAIL

STRUCTURAL NOTES CODE: 10H 055C. AND 20H 0RSC. CODE: TON ODBL. AND YOM URBL. DEBIGN LOAD - AS REQUIRED LIVE LOAD - 40 PS SKIMIC - DI SEISHIC DESIGN CATEGORY PER ORS.C. IND. - ASCE I Borgh 3-SEC QUIST EXP. C 50IL BEARNIG - BOO PSF ASSIMED EARTHURRS. L EXCAVATE TO LINES 4 LEVELS SHOWN ON DRAWINGS, ALL FOOTINGS TO BEAR ON FIRM UNDISTURBED NATIVE SANDS CONCRETE. 1. REFERENCE SPECIFICATION - ACI 301. PLANT HIX PER ASTH C94. 2. STRENGTH: 1. REPERBING SPECINGATION - ACJ 301. FLANT MIX PER ASTM C94. 2. STERNATH: A. GROND FLOOR SLAB - SCOO PSI AT 28 DAYS B. POOTINGS, WILL D STOO PSI 0 28 DAYS 3. RENFORCING - ASTM ASE, GRADE 60. LAP BARS AS SHOUN ON PLAN WITH HIS LAP OF 44 DAR DIAPETERS, PROVIDE 24" HOOKS AT CORNERS. BOLTS: A. ANCHOR BOLTS - ASTM ASOT B. EXPANSION BOLTS - HILT HERE SOO SO OR SPECON BET-XP. SPECIAL INSPECTION REQUIRED. 5. COVER - AS POLLOUS INLESS SHOUN OTHERWISE ON PLANS. A. CONCRETE PLACED SAMIST EARTH - 3" B. FORTED CONCRETE ASAINST EARTH - 2". C. SECON FLOOR SLAS CASHINET. SUBSTITUTES (4 COPIES) A. MIX DESIGNS FER IBC BOS B. REINFORCING SHOP DRAWINGS MIXED STATES. A. CONCRETE AS A COPIES A. MIX DESIGNS FER IBC BOS B. REINFORCING SHOP DRAWINGS

A MIX DESKAS PER IBC POOD
B. REINFORCHS 64OP DRAINGS

CARPENIEST.

LIPERER - DOUGLAS FIR WITH MOSINER CONTENT PER SPECFICATION. ALL
N CONTACT WITH CONCRETE TO DE PRESSURE PRESERVATIVE TREATED.
GRADE AS FOLLOUS.
A POSTS AND DEAYS 6X AND GREATER - D.P. NO 1.
B. POSTS AND DEAYS 6X AND GREATER - D.P. NO 2 OR BETTER
C. BILDS - D.P. BILD GRADE OR BETTER
D. PLATES 1 BILLS - DP NO. 2 PT. AT CONCRETE SLAB.
- KILL PRIED DP. STANDARD TYPICAL

S. SEATHING - PT YUDDO, ORDITED STRANDBLOAD OR APPROVED EQUAL
A ROOF I WILL SHEATHING - APA - 400.A. THICKNESS I MILLIES FER FLAN
B. RLORS SEATHING - APA - 400.A. THICKNESS I MILLIES FER FLAN
C. PL. TUDDO, DEBIS IN THE SERVES OR APPROVED EQUAL
BRIDGING. BLOCKING I ERECTION BRACKES FER THANFACTURERS
RECOTTENDATION.

S. GLIE LAYNATED BEA'S - DOUGLAS FIR COMBINATION 24"-V, FABRICATED WITH
WATER PROOF GLIE FINSH FER PROJECT SPECIFICATION.

C. PT. GLIE LAYNATED BEA'S - DOUGLAS FIR COMBINATION 24"-V, FABRICATED WITH
WATER PROOF GLIE FINSH FER PROJECT SPECIFICATION.

1. GLIEL LAYNATED COLUMNS - DOUGLAS FIR COMBINATION 24"-V, FABRICATED
WITH WATER PROOF GLIE FINSH FER PROJECT SPECIFICATION.

1. GLIEL LAYNATED COLUMNS - DOUGLAS FIR COMBINATION 24"-V, FABRICATED
WITH WATER PROOF GLIE FINSH FER PROJECT SPECIFICATION.

1. GLIEL LAYNATED COLUMNS - DOUGLAS FIR COMBINATION 24"-V, FABRICATED
WITH WATER PROOF GLIE FINSH FER PROJECT SPECIFICATION.

3. THERESTRAND BEATS - 3-10", 15" OF TRIS JOIST

10. THERESTRAND BEATS - 3-10", 15" OF TRIS JOIST

11. CONCRETIONS - SPECIAL STRONG THE FOURT FOR USE JOIST

12. CONCRETIONS - SPECIAL STRONG THE FOURT FOR USE JOIST

13. THERESTRAND BEATS - 3-10", 15" OF TRIS JOIST

14. THERESTRAND BEATS - 3-10", 15" OF TRIS JOIST

15. THERESTRAND BEATS - 3-10", 15" OF TRIS JOIST

16. THERESTRAND BEATS - 3-10", 15" OF TRIS JOIST

17. THERESTRAND BEATS - 3-10", 15" OF TRIS JOIST

18. THERESTRAND BEATS - 3-10", 15" OF TRIS JOIST

19. THERESTRAND BEATS - 3-10", 15" OF TRIS JOIST

19. THERESTRAND BEATS - 3-10", 15" OF TRIS JOIST

10. THERESTRAND BEATS - 3-10", 15" OF TRIS JOIST

COMMON WIRE NAIL	PNEUMATIC NAIL DIAMETER	MINIMUM NAIL Length	nàil Application
300 COMMO	0201*# P-NAIL	4-1/2"	3X DECKING
400 control	0225"# P-NAIL	5*	4X DECKING
20D COMMON	0.192°+ P-NAIL	4*	FRAMING
6D CONTON	0.162** P-NAIL	3-1/2"	FRAHING
IOD COMMON	OMB" P-NAIL	3*	FRAHING
N/A	OMB" P-NAIL	2-3/8*	FLR SHEATHING
8D COMMON	0131"+ P-NAIL	2-1/2"	ROOF SHEATHING
N/A	0.162*+ P-NAIL	3-1/2"	5TRAP5

N/A O/62** P-N/AIL 3-1/2* 5TRA#5

IL DRYING - PRIOR TO NSTALLATION OF GYPSIM WALL BOARD, DRY COMPLETED
TO A MAYNIM MOSINES CONTENT OF BUT
S. SURMITMALS - SUPP DRAWINGS, 4 COPIES.

IS. SURMITMALS - SUPP DRAWINGS, 4 COPIES.

IA. PREFAREACATED UGOD TRISSESS
A. REFERENCE SHADDARD - ANN I / THI L.


I. PREFAREACATED UGOD TRISSESS
DESIGNED AND FARRICATED TO SUPPORT THE LOADS SHOUN WITH A TOTAL
LOAD DETRECTION LESS THAN LOGO.

C. SURMITMALS, 12 COPIES)
91 PRICINFAL CALCULATIONS STAMPED BY AN ENGINEER REGISTERED
IN OREGON IS SUPPORTED.

PRECIDENAL CALCULATIONS STAMPED BY AN ENGINEER REGISTERED
IN OREGON SHOP DRAWINGS SHOUNG ALL FABRICATION,
ERECTION AND INSTALLATION DETAILS.

II. BLIESS NOTED OTHERWISE, ALL BEA'15 1 GIRDER TRISSES TO BE
SUPPORTED AT BIODS BY
LOCATED IN WALL CONTINEON ALL FLOORS DUTA TO
FORMOATION WITH SOLD PLOCKING AT FLOORS. CAN STUDS
TOCKITER WITH SOLD PLOCKING AT FLOORS. CAN STUDS
TO CONTINUES FOR PLIL HEIGHT DOWN TO SOLD BEARNS.

MARK	REF NOTES: (1,9) SHEATHING	Note: (2) NAIL SIZE	EDGE NAILYG SPACING	FIELD NAILYG SPACING	SILL TO CONCRETE CONNECTION, NOTE: (3)	SILL TO LOOD CONNECTION Note (1)	SHEAR TRANSFER CLIPS (8)
A	1/4" OSB (1) SIDE (6)	8d	6'	12*	b" DIA TITEN ANCHORS OR b" DIA AB. • 42" D/C	16D • 6' O/C	A35 OR RBC # 24" O/C
В	1/4" OSB (1) SIDE (6)	8d	4*	יט	IS DIA TITEN ANCHORS OR IS DIA AB. 0 24" O/C (12)	16D 4 4' O/C	4 16" O/C
NOTES:							
D C-E	D-C SHEATHING, PLYWOO	D PANEL 61	ONG AND OTHER	GRADES COVE	RED IN PSI-95. ALL WALL CONSTR	RUCTION TO CONFORM TO 06	sc
TA	BLE 2306.41						
2) USE	COMMON WIRE NAILS FOR	ALL WOOD 5	HEATHING AND C	COLER NAIL6 FO	OR GYPBOARD GHEATHING		
3) AB.	MINIMUM I' EMBED INTO C	ONCRETE 3	X3"X4" PLATE I	MSHERS REGIT	AT ALL SHEAR WALL AB.'s. N/A	# MASA ANCHORS.	
4) PANEL JOINTS SHALL BE OFFSET TO FALL ON DIFFERENT FRAMING MEMBERS OR FRAMING SHALL BE 3X OR THICKER AND NAILS ON EACH SIDE							
SHALL BE STAGGERED.							
5) 3X (OR DBL 2X FRAMING AT AL	L ADJOINING	PANEL EDGES A	ND NAILS SHAL	L BE STAGGERED.		
6) ALL EDGES BLOCKED.							
1) COMMON URSE NAILS.							
B) CLIP TO BE ATTACHED FROM CONTINUOUS BLOCKING TO TOP OF CONTINUOUS BLOCKI							
CLIPS ARE NOT REQUIRED AT GYP BD WALLS BUT BLOCKING IS ATTACHED FER THE TORNALING SCHEDULE							
9) SEE ATTACHED TYPICAL SHEARWALL DETAILS.							
D) SHEATHING TO BE STRUCTURAL I SHEATHING.							
II) VALUES ARE FOR FRAMING OF H.F.							
12) SEE PLAN FOR WALLS WHERE SEISMIC DESIGN SHEAR IS GREATER THAN 350 PLF (ASD), 3X OR DBL 2X AT PANEL EDGES AND SILL							
STAGGER NAIL 6. NAIL AND GLUE DBL 2X SILL TOGETHER U KIND GALVANIZED • 4" O/C STAGGERED, OR USE A 3X.							
FOR WALLS WITH THE LARGER SILLS, ANCHOR BOLT SPACING MAY BE INCREASED BY A FACTOR OF US FROM THE TABLE ABOVE DUE TO THICKER SILLS.							
	PLY IS ACCEPTABLE IN						
C. 1710	TEL TO PRODE INCHES						

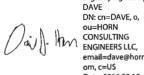

Digitally signed by DAVE DN: cn=DAVE, o. ou=HORN email=dave@hornce.c om, c=US Date: 2016.09.12 16:17:44 -07'00'





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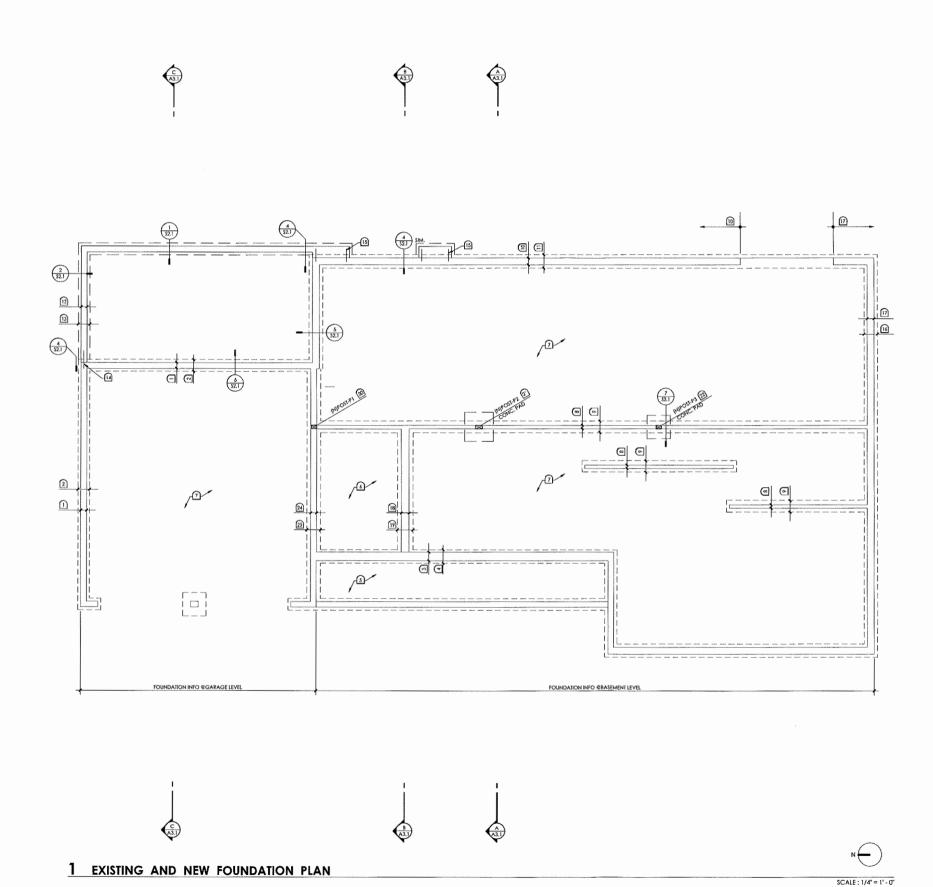
OF NAME

O91060 WAND E, OR 9 ШÌ ٣뚝 31710 TROUTDA

SHEAR WALL SCHEDULE / STRUCTURAL NOTES

REVISIONS:	
DATE:	9.12.16
SCALE:	
DRAUN:	JPG
JOB NO:	C2D-16-01


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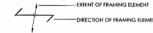


FOUNDATION PLAN GENERAL NOTES

- A. REFER TO ARCHITECTURAL PLANS WHERE DIMENSIONS NOT PROVIDED
- B. ANY DISCREPANCIES BETWEEN ARCH, DWGS, & STRUCT, DWGS, SHALL BE BROUGHT TO THE ATTENTION OF THE DESIGNER PRIOR TO PROCEEDING
- ANY DISCREPANCIES BETWEEN THE STRUCT, DWGS, & IN-FIELD CONDITIONS SHALL BE BROUGHT TO THE ATTENTION OF THE DESIGNER PRIOR TO PROCEEDING
- D. REFER TO STRUCTURAL CALCULATIONS AND LAYOUT BY STRUCTURAL ENGINEER FOR ADDITIONAL INFO

FOUNDATION PLAN LEGEND



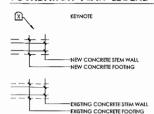

FOUNDATION PLAN KEYNOTES

(E) INDICATES EXISTING CONSTRUCTION. (N) INDICATES NEW CONSTRUCTION, ALL NOTES ARE FOR NEW WORK UNLESS

- 1. (E)CONC, STEM WALL 6" WIDE
- 2. (E)CONC. FOOTING 6" x 12"
- 3. (E)CONC. STEM WALL 7" WIDE
- 4, (E)CONC. FOOTING 6" x 14" 5. (E)COMPACTED FILL
- 6. (E)PARTIALLY UNEXCAVATED AREA
- 7. (E)CONC. SLAB
- 8. (E)CONC. STEM WALL 3 1/2" WIDE FIELD VERIFY
- 9. (E)CONC, FTG, 6" x 14"
- 10. (E)CONC, RET, WALL 7" WIDE FIELD VERIFY
- 11. (E)CONC. FTG. 6" x 14" FIELD VERIFY
- 12. CONC. STEM WALL 6" WIDE . 13. CONC. STEM WALL - 6" x 12" CONT.
- STEEL DOWEL AT (N)FOUNDATION/ (E)FOUNDATION INTERFACE
- 15. STEEL DOWEL AT (N)FOUNDATION/ (E)FOUNDATION INTERFACE
- 16. (E)CONC. FTG.
- 17. (E) CRIPPLE STUD WALL W/ CONC. STEM WALL
- 18. (E)CONC. RET, WALL 19. (E)CONC. FTG.
- POST P1; 4 x 6 D.F.-L. #2
 TO (E)CONC. STEM WALL
- 21. POST P2; 4 x 8 D.F.-1., #2 W/ CONC, PAD 2'-6" x 2'-6" x 1'-0" W/ 3#4'S EA, WAY
- 22. POST P3; 4 x 6 D.F.-L. #2 W/ CONC. PAD 2-0" x 2-0" x 10" W/ 2#4'S EA. WAY
- 23. NOT USED
- (E)6" CONC. STEM WALL: +/- 3'-6" ABOVE FIN. GR OF PARTIALLY UNEXCAVATED AREA- FIELD VERIFY
- 25. (E)CONC. FTG. 6 x 14 FIELD VERIFY

Greenslade Residence Alterations

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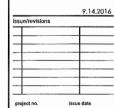
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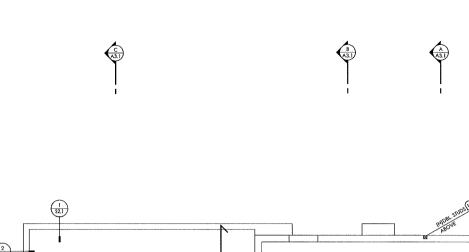
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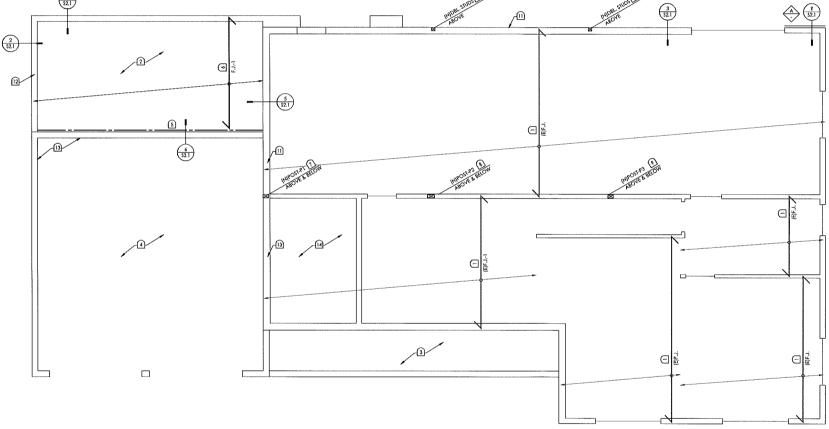


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FOUND. PLAN FLR. FRMG. PLAN

sheet number







FLOOR FRAMING PLAN GENERAL NOTES

- A. REFER TO ARCHITECTURAL PLANS WHERE DIMENSIONS NOT PROVIDED
- B. ALL DIMENSIONS ARE FROM F.O. STUD OR F.O. CONCRETE U.N.O.
- C. ANY DISCREPANCIES BETWEEN ARCH, DWGS, & STRUCT, DWGS, SHALL BE BROUGHT TO THE ATTENTION OF THE DESIGNER PRIOR TO PROCEEDING
- ANY DISCREPANCIES BETWEEN THE STRUCT, DWGS, & IN-FIELD CONDITIONS SHALL BE BROUGHT TO THE ATTENTION OF THE DESIGNER PRIOR TO PROCEEDING

FLOOR FRAMING PLAN LEGEND

EXTENT OF FRAMING ELEMENT - DIRECTION OF FRAMING ELEMENT INDICATES SHEAR WALL TYPE PER SCHEDULE SHT. S.O - INDICATES HOLDOWN TYPE ONE PER EA. END OF WALL SEGMENT PER SCHED. SHT. S.O. WALL ABOVE FRAMING LEVEL

MAIN LEVEL FLOOR FRAMING PLAN KEYNOTES

HEADER OR BEAM

EXISTING HEADER OR BEAM

(E) INDICATES EXISTING CONSTRUCTION. (IV) INDICATES NEW CONSTRUCTION. ALL NOTES ARE FOR NEW WORK UNLESS OTHERWISE NOTED.

- 1. (E)F.J. 2 x 10 @16" O.C.
- 3/4" GLUED T & G PLYWD. OR OSB, MIN. SPAN RATING 24/16, FACE GRAIN PERPENDICULAR TO FRAMING TYP., 10d RING SHANK NAILS @ 6" O.C. EDGES, 12" O.C. FIELD
- 3. (E)CONC. SLAB OVER EXCAVATED FILL
- 4. (E)CONC. SLAB
- 5. LEDGER 2 x 8 P.T.D.F. TO (E)STUD WALL
- 6. F.J.-1: 2 x 8 @16" O.C. W/ LU HGR.
- 7. POST- P1; 4 x 6 D.F.-L. #2 TO WD. SILL PLATE OF (E) GARAGE CONC. STEM WALL
- B. POSTS- P2; 4 x 8 D.F.-L. #2 ABOVE & BELOW W/ SOLID 2 x BLKG, @ FLR, LEVEL
- 9. POSTS- P3; 4 x 6 D.F.-L. #2 ABOVE & BELOW W/ SOLID 2 x BLKG. @ FLR. LEVEL
- 10. DBL. STUDS ABOVE W/ SOLID BLKG, TO FILL HT, RETAINING WALL PLATE BELOW 11. (E)CONC. RET. WALL
- 12. CONC. STEM WALL
- 13. (E)CONC, STEM WALL
- 14. (E)UNEXCAVATED AREA

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	9.14.2016
issue/revisions	
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project no.	issue date

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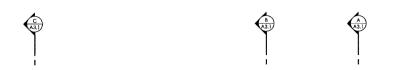
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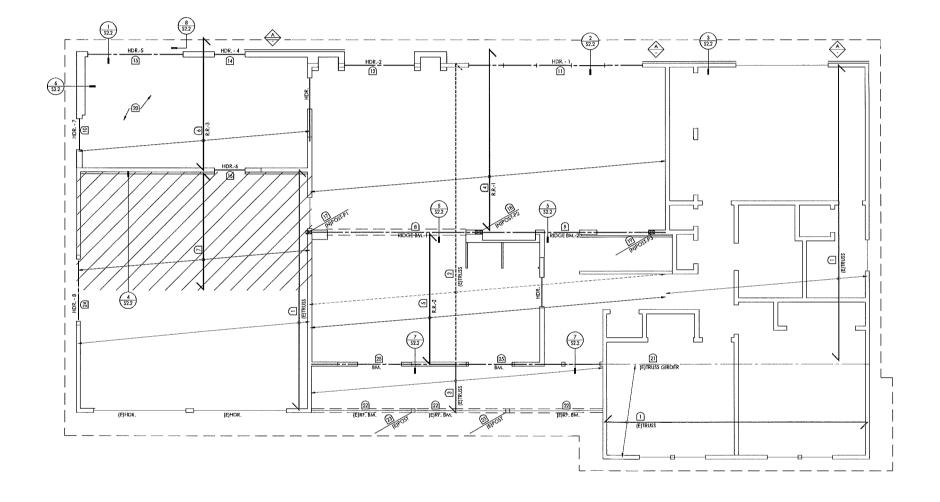
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S1.2

1 EXISTING AND NEW MAIN LEVEL FLOOR FRAMING PLAN

SCALE : 1/4" = 1' - 0"





1 EXISTING AND NEW ROOF FRAMING PLAN

A. REFER TO ARCHITECTURAL PLANS WHERE DIMENSIONS NOT PROVIDED


B. ALL DIMENSIONS ARE FROM F.O. STUD U.N.O.

C. ANY DISCREPANCIES BETWEEN ARCH, DWGS, & STRUCT, DWGS, SHALL BE BROUGHT TO THE ATTENTION OF THE DESIGNER PRIOR TO PROCEEDING

ROOF FRAMING PLAN GENERAL NOTES

D. ANY DISCREPANCIES BETWEEN THE STRUCT, DWGS. & IN-FIELD CONDITIONS SHALL BE BROUGHT TO THE ATTENTION OF THE DESIGNER PRIOR TO

ROOF FRAMING PLAN LEGEND

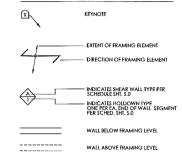

ROOF FRAMING PLAN KEYNOTES

(E) INDICATES EXISTING CONSTRUCTION. (N) INDICATES NEW CONSTRUCTION, ALL NOTES ARE FOR NEW WORK UNLESS OTHERWISE NOTED.

1. (E)MFR. WD. TRUSS TO REMAIN

(E)TRUSS CAPACITY TO BE MODIFIED INTO NON-BEARING CAPACITY BY RÉMOVAL OF BOTTOM & INTERMEDIATE CHORDS (SHOWN DASHED)

PORTION OF (E)TRUSS TO REMAIN AND MODIFIED TO RETAIN LOAD BEARING CAPACITY - SEE DETL. 7/52.2

4. R.R.-1; 2 x 10 @24" O.C. W/LSU HGR. TO RIDGE

5. R.R.-2; 2x 10 @24" O.C. W/LSU HGR. TO RIDGE & TO [E)TRUSS GIRDER(WHERE OCCURS)

6. R.R.-3; 2 x 8 @24" O.C. W/LU HGR.

7. OVERFRAMING - 2 x 4 @24" O.C.

8. RIDGE BM.-1; 3 1/2 x 12 G.L.B. RIDGE BM.-2; 3 1/2 x 12 G.L.B.

11. HDR.-1: 3 1/2 x 12 G.L.B. W/ (2) 2 x 4 TRIMMERS @EA. END

12. HDR.-2; 4 x 8 #2 D.F.

NOT USED 14. HDR.-4; 4 x 6 #2 D.F.

15. HDR.-5; 5 1/2 x 6 G.L.B.

16. HDR.-6; 4 x 8 #2 D.F.

17. POST P-1; 4 x 6 #2 D.F. W/ EPC4Z POST CAP

18. POST P-2; 4 x 8 #2 D.F. W/ PC4Z POST CAP

19. POST P-3; 4 x 6 #2 D.F. W/ PC4Z POST CAP

20. 1/Z CDX PLYWD, OR OSB W/ 24/0 MIN. SPAN RATING, FACE GRAIN PERPENDICULAR TO FRAMING - TYP., Bd @6*O.C. EDGES, 12*O.C. FIELD 21. (E) FIELD VERIFY.

22. [E]RF. BM. - 4 x 10

24. REPLACE (E)HDR @MODIFIED (E)OPENING

25. 4 x 12 ON TOP OF (E)DBL. TOP PLATES - REMOVE DBL. TOP PLATES @(N)WINDOW OPENINGS

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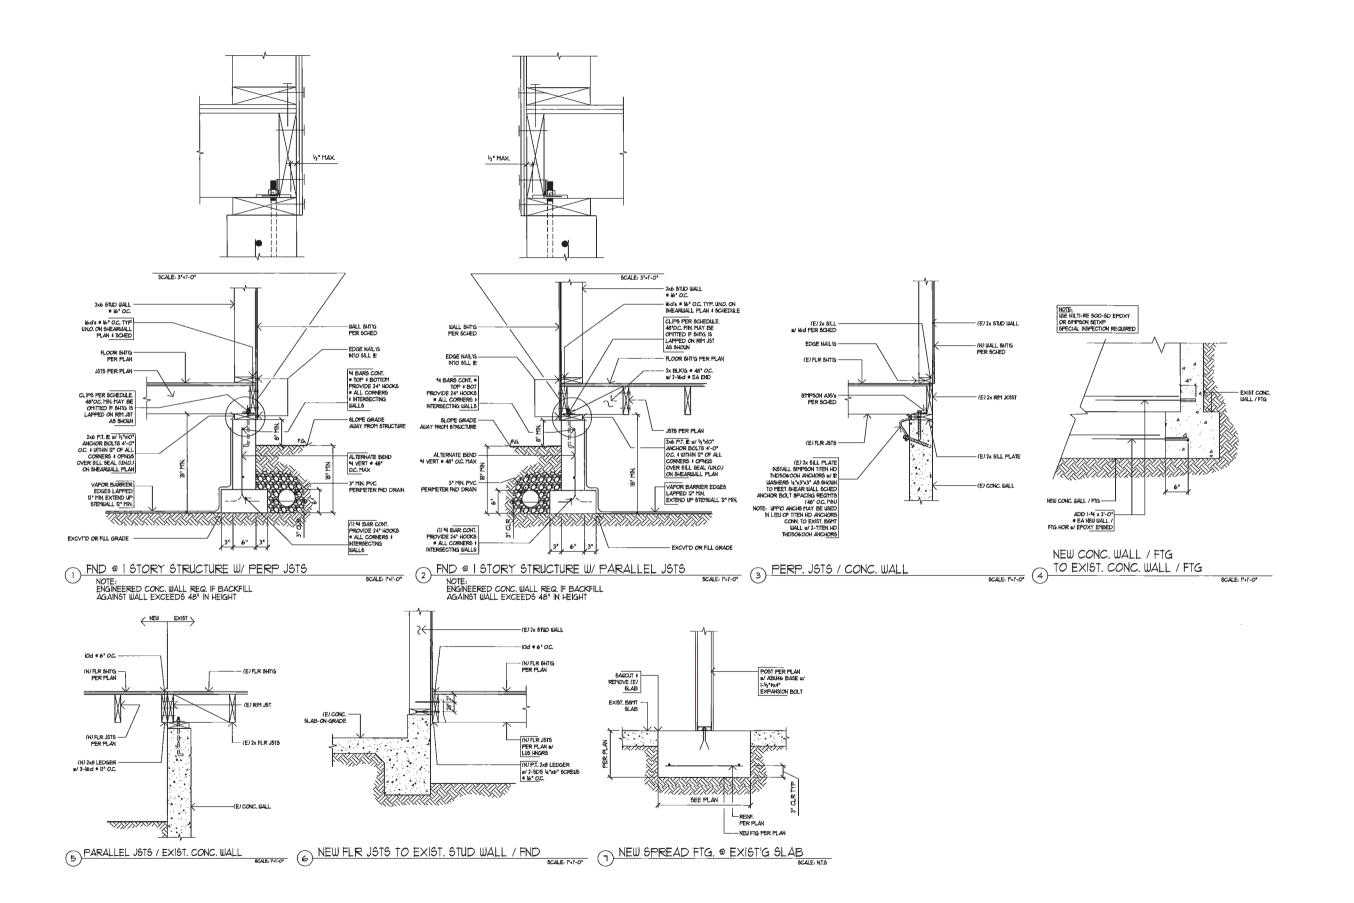
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issue/revisions	
	
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project no.	issue date

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ROOF FRAMING STRUCT. DETAILS

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31710 NE WAND RD TROUTDALE, OR 97060

DETAILS

REVISIONS:

DATE: 9.12.16


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DETAILS

REVISIONS:

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52.2

SINAL SHEET SIZE: 22x34

Home / Lighting & Ceiling Fans / Outdoor Lighting / Outdoor Wall Mounted Lighting / Outdoor Lanterns & Sconces

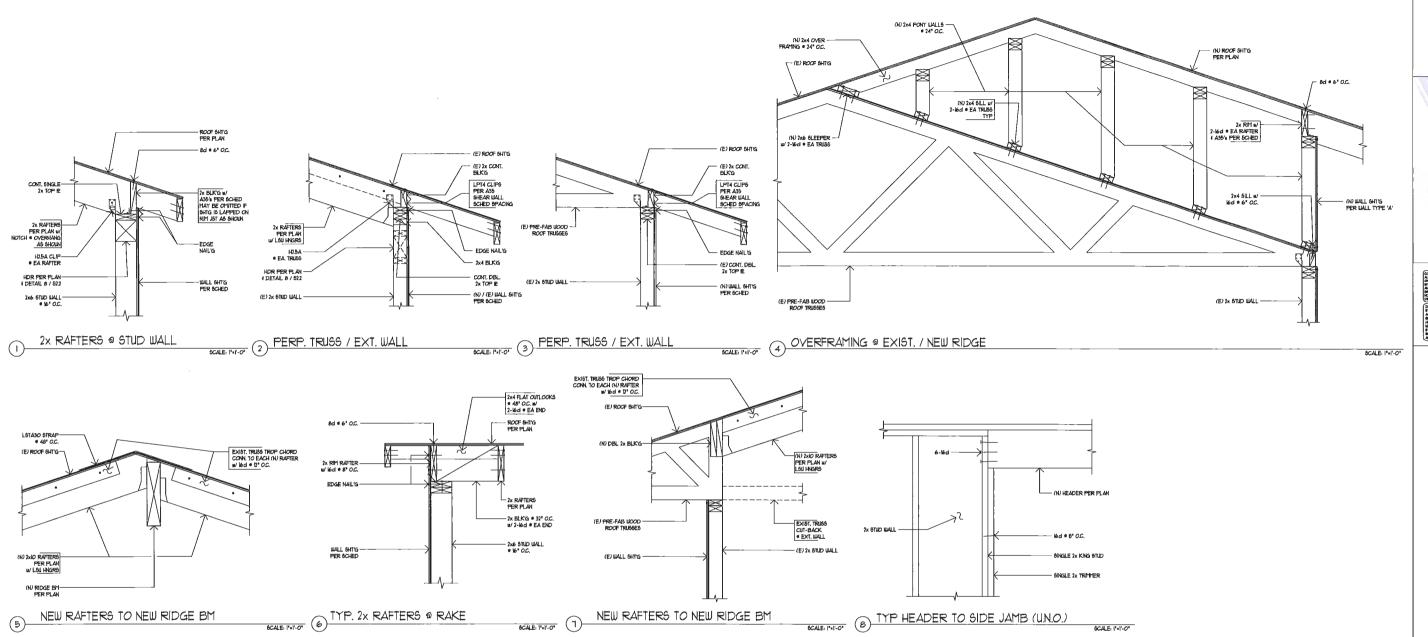Model # 8101-A138 Internet #204382683







the great outdoors by Minka Lavery Kirkham 1-Light Bronze Outdoor Wall-Mount Lantern

**** (2)

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LET'S PROTECT THIS.

Add a 2-year Home Depot Protection Plan for \$12.00

Quantity





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Product Overview

"the great outdoors by Minka Lavery" Wall-Mount 1-Light Outdoor Lantern is fully Dark Sky approved. Featuring a hammered metal shade and backplate, the finish is Aspen bronze. Install this delightfully rustic fixture in any outdoor location.

- Rugged yet light weight, the aluminum housing is perfect for installation outdoors
- Recessed bulb is fully shielded, IDA dark sky approved
- Uses one 60-Watt medium base bulb, also accepts CFL
- ETL listed for installation in wet locations
- Click here for more information on Electronic Recycling Programs

Info & Guides

Installation Guide

Instructions / Assembly

Use and Care Manual

You will need Adobe® Acrobat® Reader to view PDF documents. Download a free copy from the Adobe Web site.

Specifications

Dimensions

7/20/2017 the great outdoors by Minka Lavery Kirkham 1-Light Bronze Outdoor Wall-Mount Lantern-8101-A138 - The Home Depot	ot
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Product Denth (in.) Product Height (in.)	10.5	
Product Length (in.)	10.5	
Product Width (in.)	8.5	

Details

Exterior Lighting Product Type	Outdoor Lanterns
Fixture Color/Finish	Aspen Bronze
Fixture Material	Aluminum
Glass/Lens Type .	No glass/lens
Included	Hardware Included
Light Bulb Base Code	E26
Light Bulb Type Included	No Bulbs Included
Maximum Bulb Wattage	60 W
Maximum Wattage (watts)	60
Number of Bulbs Required	1
Outdoor Lighting Features	Dark Sky,Weather Resistant
Power Type	Hardwired
Product Weight (lb.)	.9lb
Recommended Light Bulb Shape Code	A19
Returnable	90-Day
Style	Classic
1	

Warranty / Certifications

Certifications and Listings	ETL Listed
Manufacturer Warranty	One (1) year limited warranty

How can we improve our product information? Provide feedback.